90% DESIGN REVIEW OCTOBER 4, 2019

INDEX OF SHEETS

SHEET NO. DESCRIPTION

1 Title Sheet

1A Index Of Sheets Cont'd. & Std. Dwg. Nos.

**Project Site** 

Plans for Proposed Project Grading, Drainage, Structures, Paving, Striping,

Signing, Illumination & Roadside Development

# Errol Heights Street and Storm Drainage Improvements


SE Malden Drive (SE 45th Ave to SE 52nd Ave)
SE Nehalem Street (SE 46th Ave to SE Tenino Drive)
SE Tenino Drive (SE 45th Ave to SE Malden Drive)
SE Tenino Court (SE Tenino Drive to SE 52nd Ave)
SE 48th Ave (SE Malden Drive to SE Tenino Drive)
SE 49th Ave (SE Malden Drive to SE Tenino Court)
SE 51st Ave (SE Malden Drive to SE Tenino Court)
SE 45th Ave
SE Harney Drive
SE 52nd Ave

Multnomah County October 2019



LOCATION MAP

1000 2000 3000 4000

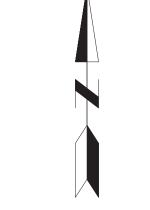

T. 1 S., R. 2 E., W.M.

ATTENTION: OREGON LAW REQUIRES YOU TO FOLLOW RULES ADOPTED BY THE OREGON UTILITY NOTIFICATION CENTER. THOSE RULES ARE SET FORTH IN OAR 952-001-0010 THROUGH OAR 952-001-0090. YOU MAY OBTAIN COPIES OF THE RULES BY CALLING THE CENTER.

RULES ARE ALSO LOCATED AT WWW.DIGSAFELYOREGON.COM NOTE: THE TELEPHONE NUMBER FOR THE OREGON UTILITY NOTIFICATION CENTER IS (503)-232-1987.

POTENTIAL UNDERGROUND FACILITY OWNERS

# Dig Safely.

Website: http://www.callbeforeyoudig.org/ Call the Oregon One-Call Center DIAL 811 or 1-800-332-2344

EMERGENCY TELEPHONE NUMBERS

NW NATURAL GAS

M-F 7am-6pm 503-226-4211 Ext.4313

AFTER HOURS 503-226-4211

PGE 503-464-7777


CENTURYLINK 1-800-573-1311

BUREAU OF TRANS./MAINT. OPERATIONS 503-823-1700

 BUREAU OF TRANS./MAINT. OPERATIONS
 503-823-1700

 CITY WATER
 503-823-4874

 VERIZON
 1-800-483-1000

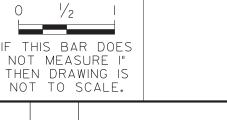

WARNING

NOT TO SCALE.

DESIGNED BY D. Murar/L. Burke

CAD BY CAD BY
R. Cadua

CHECKED BY
C. Vanderzanden

NO. DATE

DESCRIPTION

DATE APPROVED
D. Murar/L. Burke

CAD BY
C. Vanderzanden

APPD.

REVISION

FOR REVIEW ONLY

SUPI

APPROVALS:

SUPERVISING ENGINEER REG. PROF. ENGR. NO. 14956PE

CITY ENGINEER REG. PROF. ENGR. NO. 51538PE

FEET





Крп

Errol Heights
Street and Storm Drainage Improvements


Cover Sheet

PROJECT NO.
T00526.D42

SHEET NO.

1

111 SW Fifth Ave., Suite 2500
Portland, OR 97204
O: 503.227.3251
F: 503.224.4681
www.kpff.com

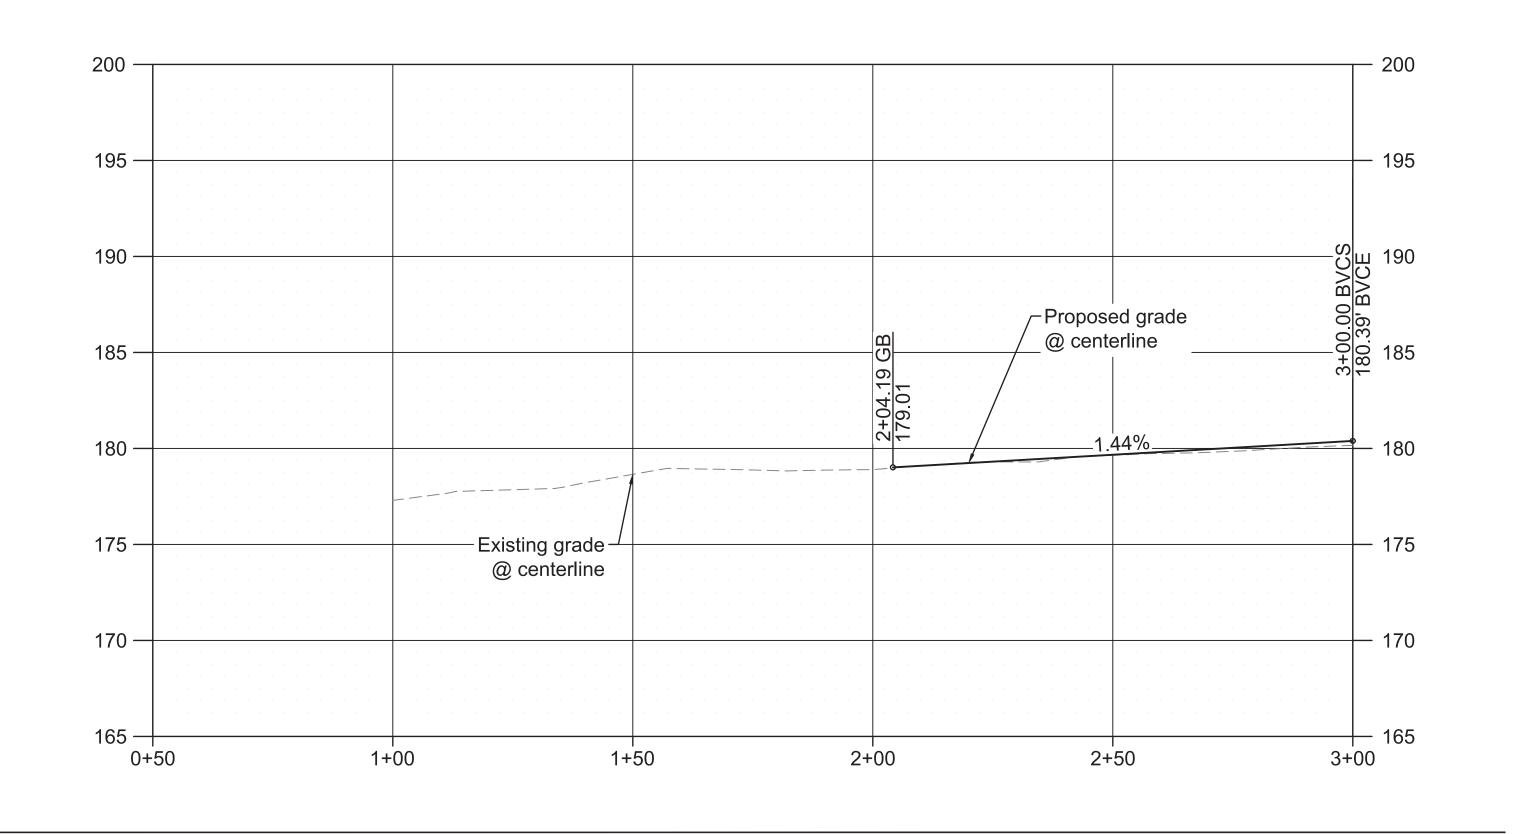

SCALE: 1" = 20' 1" = 5' 65 Begin monolithic curb, 4411 SE Rex St 4515 SE Malden Dr sidewalk and rock gallery 4636 SE 45th Ave S.E. Malden Drive S.E. Rex Street 45th 4416 SE Rex St (typ.) (2)-"M" 2+03.87
Begin standard curb

S.E. MALDEN DRIVE - PROFILE VIEW

S.E. MALDEN DRIVE - PLAN VIEW

SCALE: 1" = 20'

IF THIS BAR DOES NOT MEASURE I' THEN DRAWING IS NOT TO SCALE.

### General Notes:

1 See Shts. 2H-1 thru 2H-13 for Tree Protection Plans


90% DESIGN REVIEW


OCTOBER 4, 2019

- 2 See Shts. D-1 thru D-15 for Drainage Plans.
- 3 See Shts. S-1 thru S-4 for Signing and Striping Plans.
- 4 See Shts. L-1 thru L-15 for Landscape Plans.

## O Construction Notes

- 2 Limits of cut/fill.
- 3 Sawcut pavement.
- 12 Protect fence.
- 13 Remove fence and salvage to owner.
- 21 Utility pole to remain. Coordinate with utility company to hold/adjust pole elevation as necessary for grading.
- 22 Adjust box to finished grade.
- 32 Relocate mailbox. See Std. Drg. No. RD100 and RD101.
- 40 Construct standard curb. See Std. Drg. No. P-540.
- 45 Construct asphalt driveway connection. See Std. Drg. No.
- 65 Construct monolithic concrete curb and sidewalk. See Std. Drg. No. P-551.
- 66 Construct end of sidewalk transition. See Std. Drg. No. RD754.
- 68 Construct fully lowered concrete driveway. See Std. Drg. No. P-531.

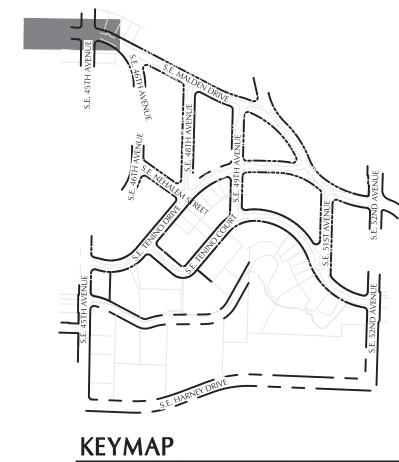

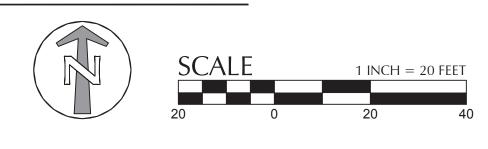



111 SW Fifth Ave., Suite 2500 Portland, OR 97204 O: 503.227.3251 F: 503.224.4681 www.kpff.com Errol Heights
Street and Storm Improvements 1s2e19

T00526.D42 SHEET NO.

PORTLAND BUREAU OF TRANSPORTATION


COMMISSIONER


S.E. Malden Drive Street Plan and Profile


D. Murar / L. Burke CAD BY R. Cadua SUPERVISING ENGINEER REG. PROF. ENGR. NO. 14956PE CHECKED BY C. Vanderzanden NO. DATE DESCRIPTION APPD. CHLOE EUDALY CITY ENGINEER REG. PROF. ENGR. NO. 51538PE CITY ENGINEER STEVE TOWNSEN, P.E. REVISION

DESIGNED BY

APPROVALS:

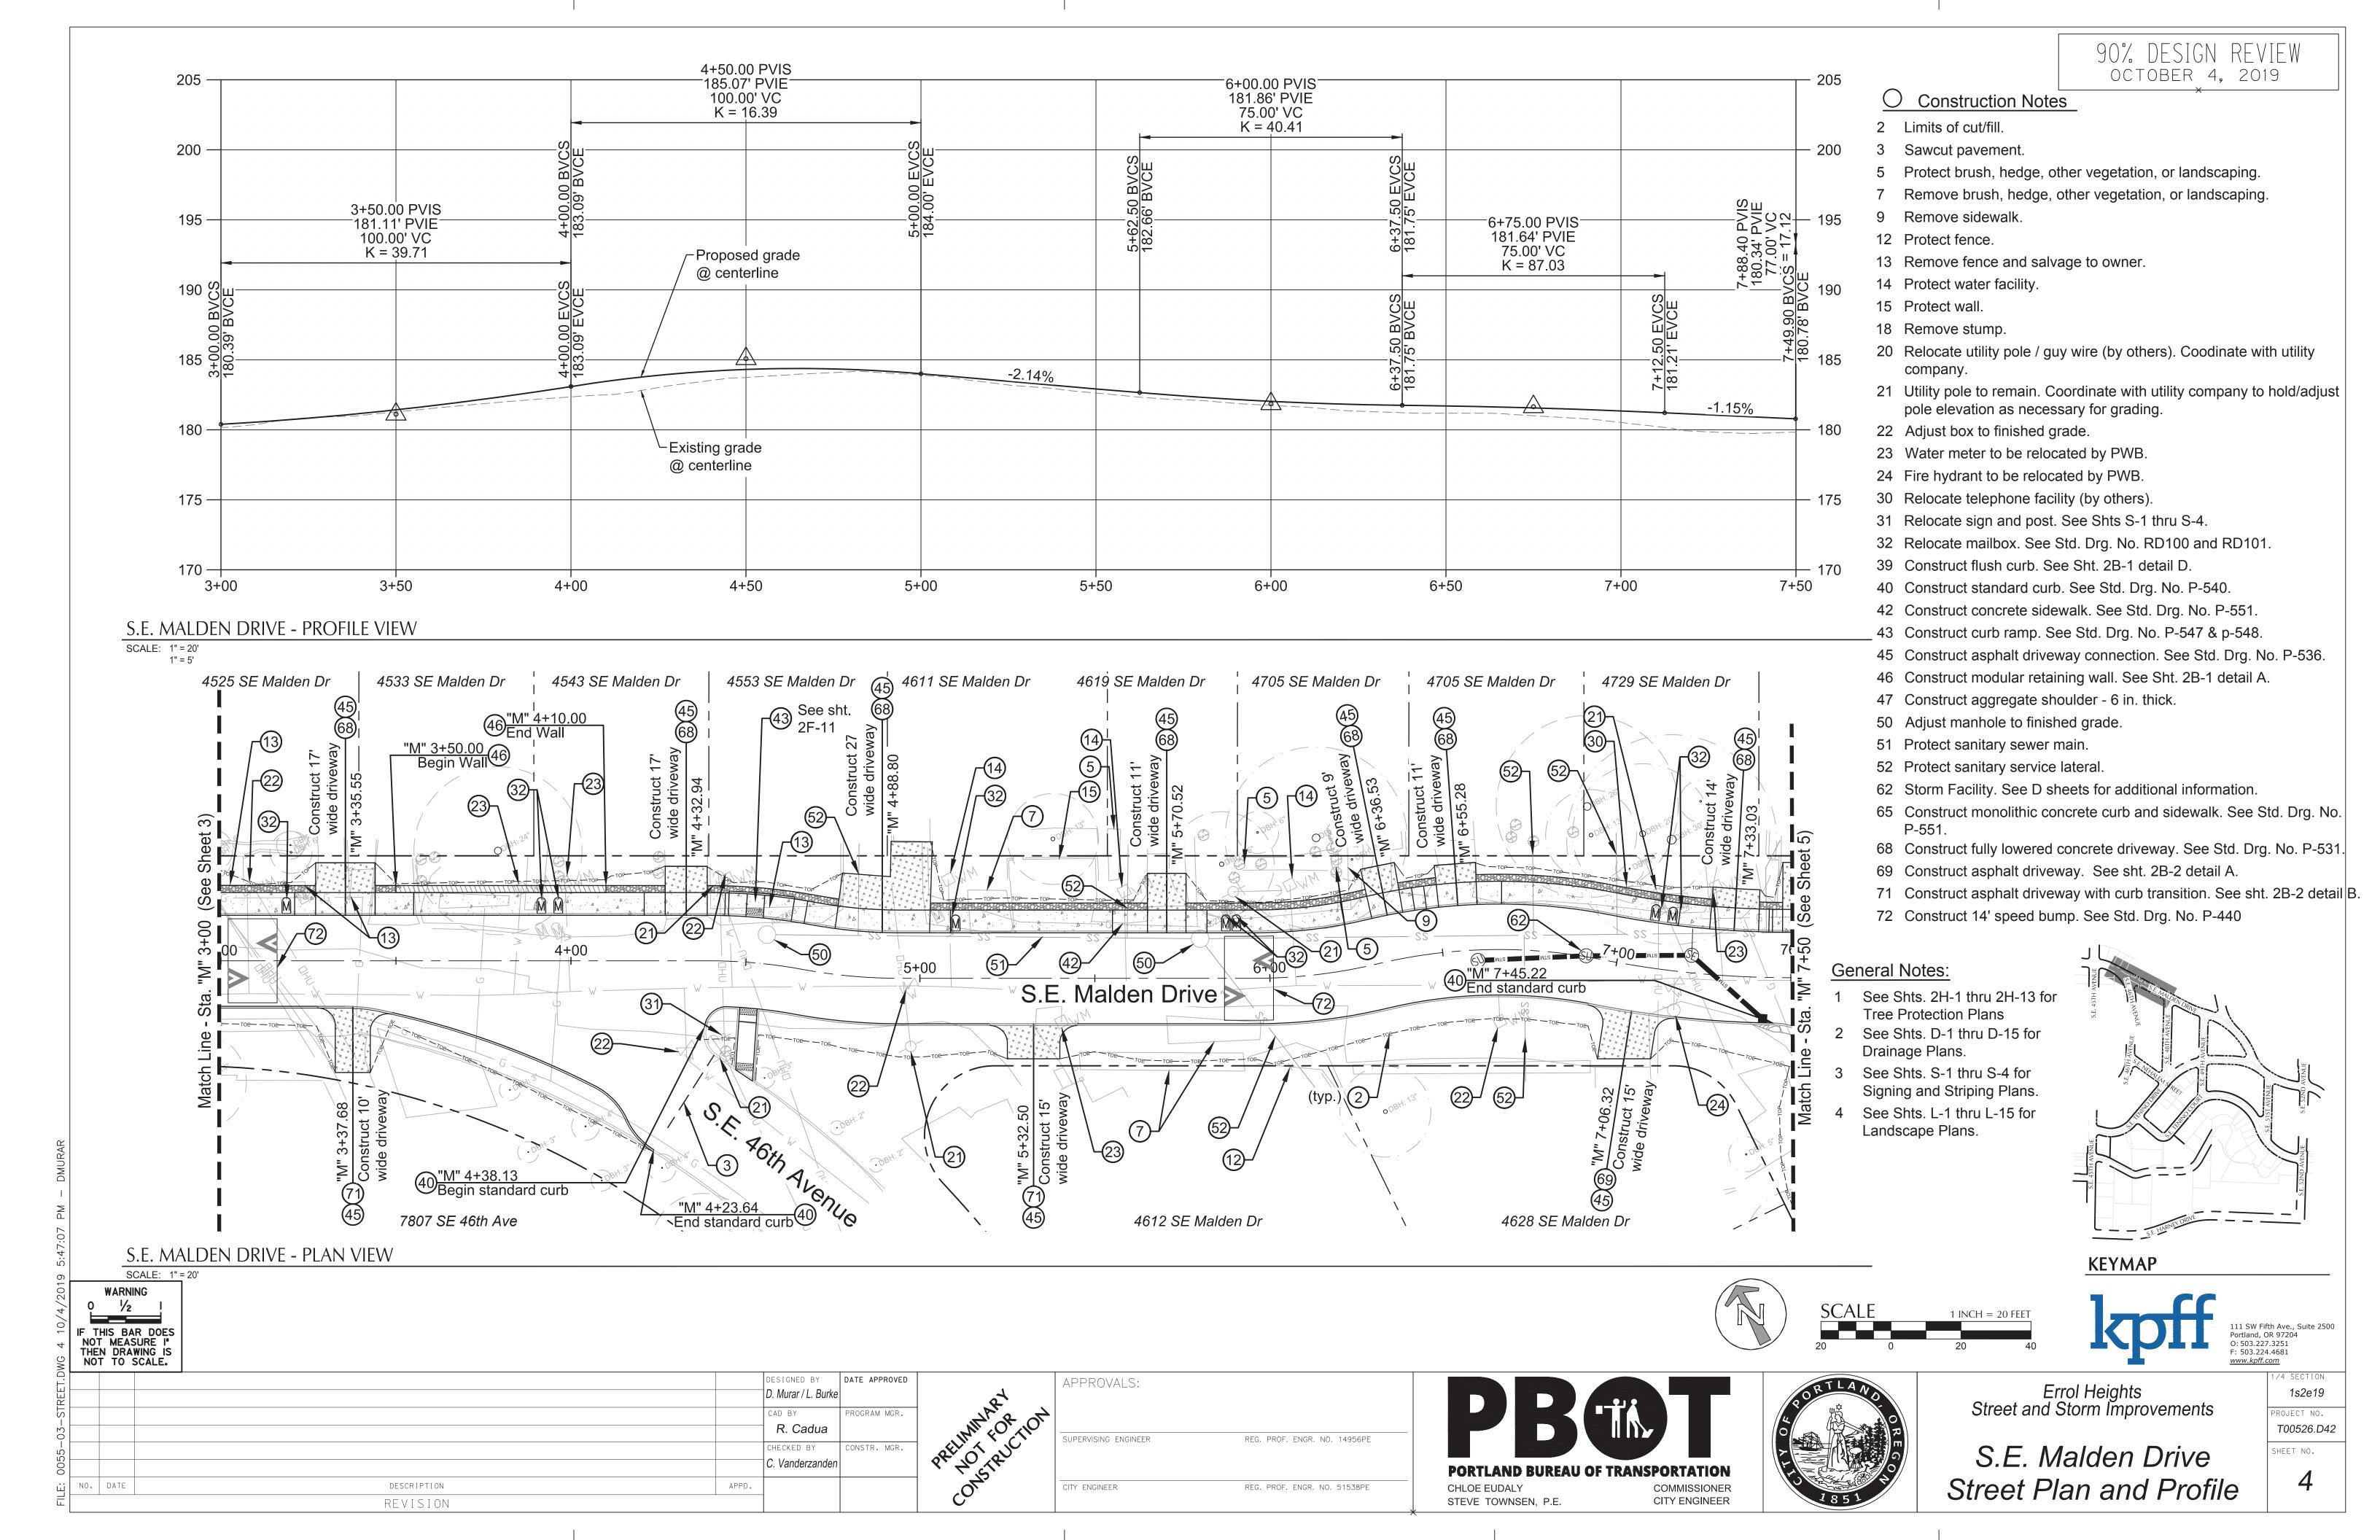

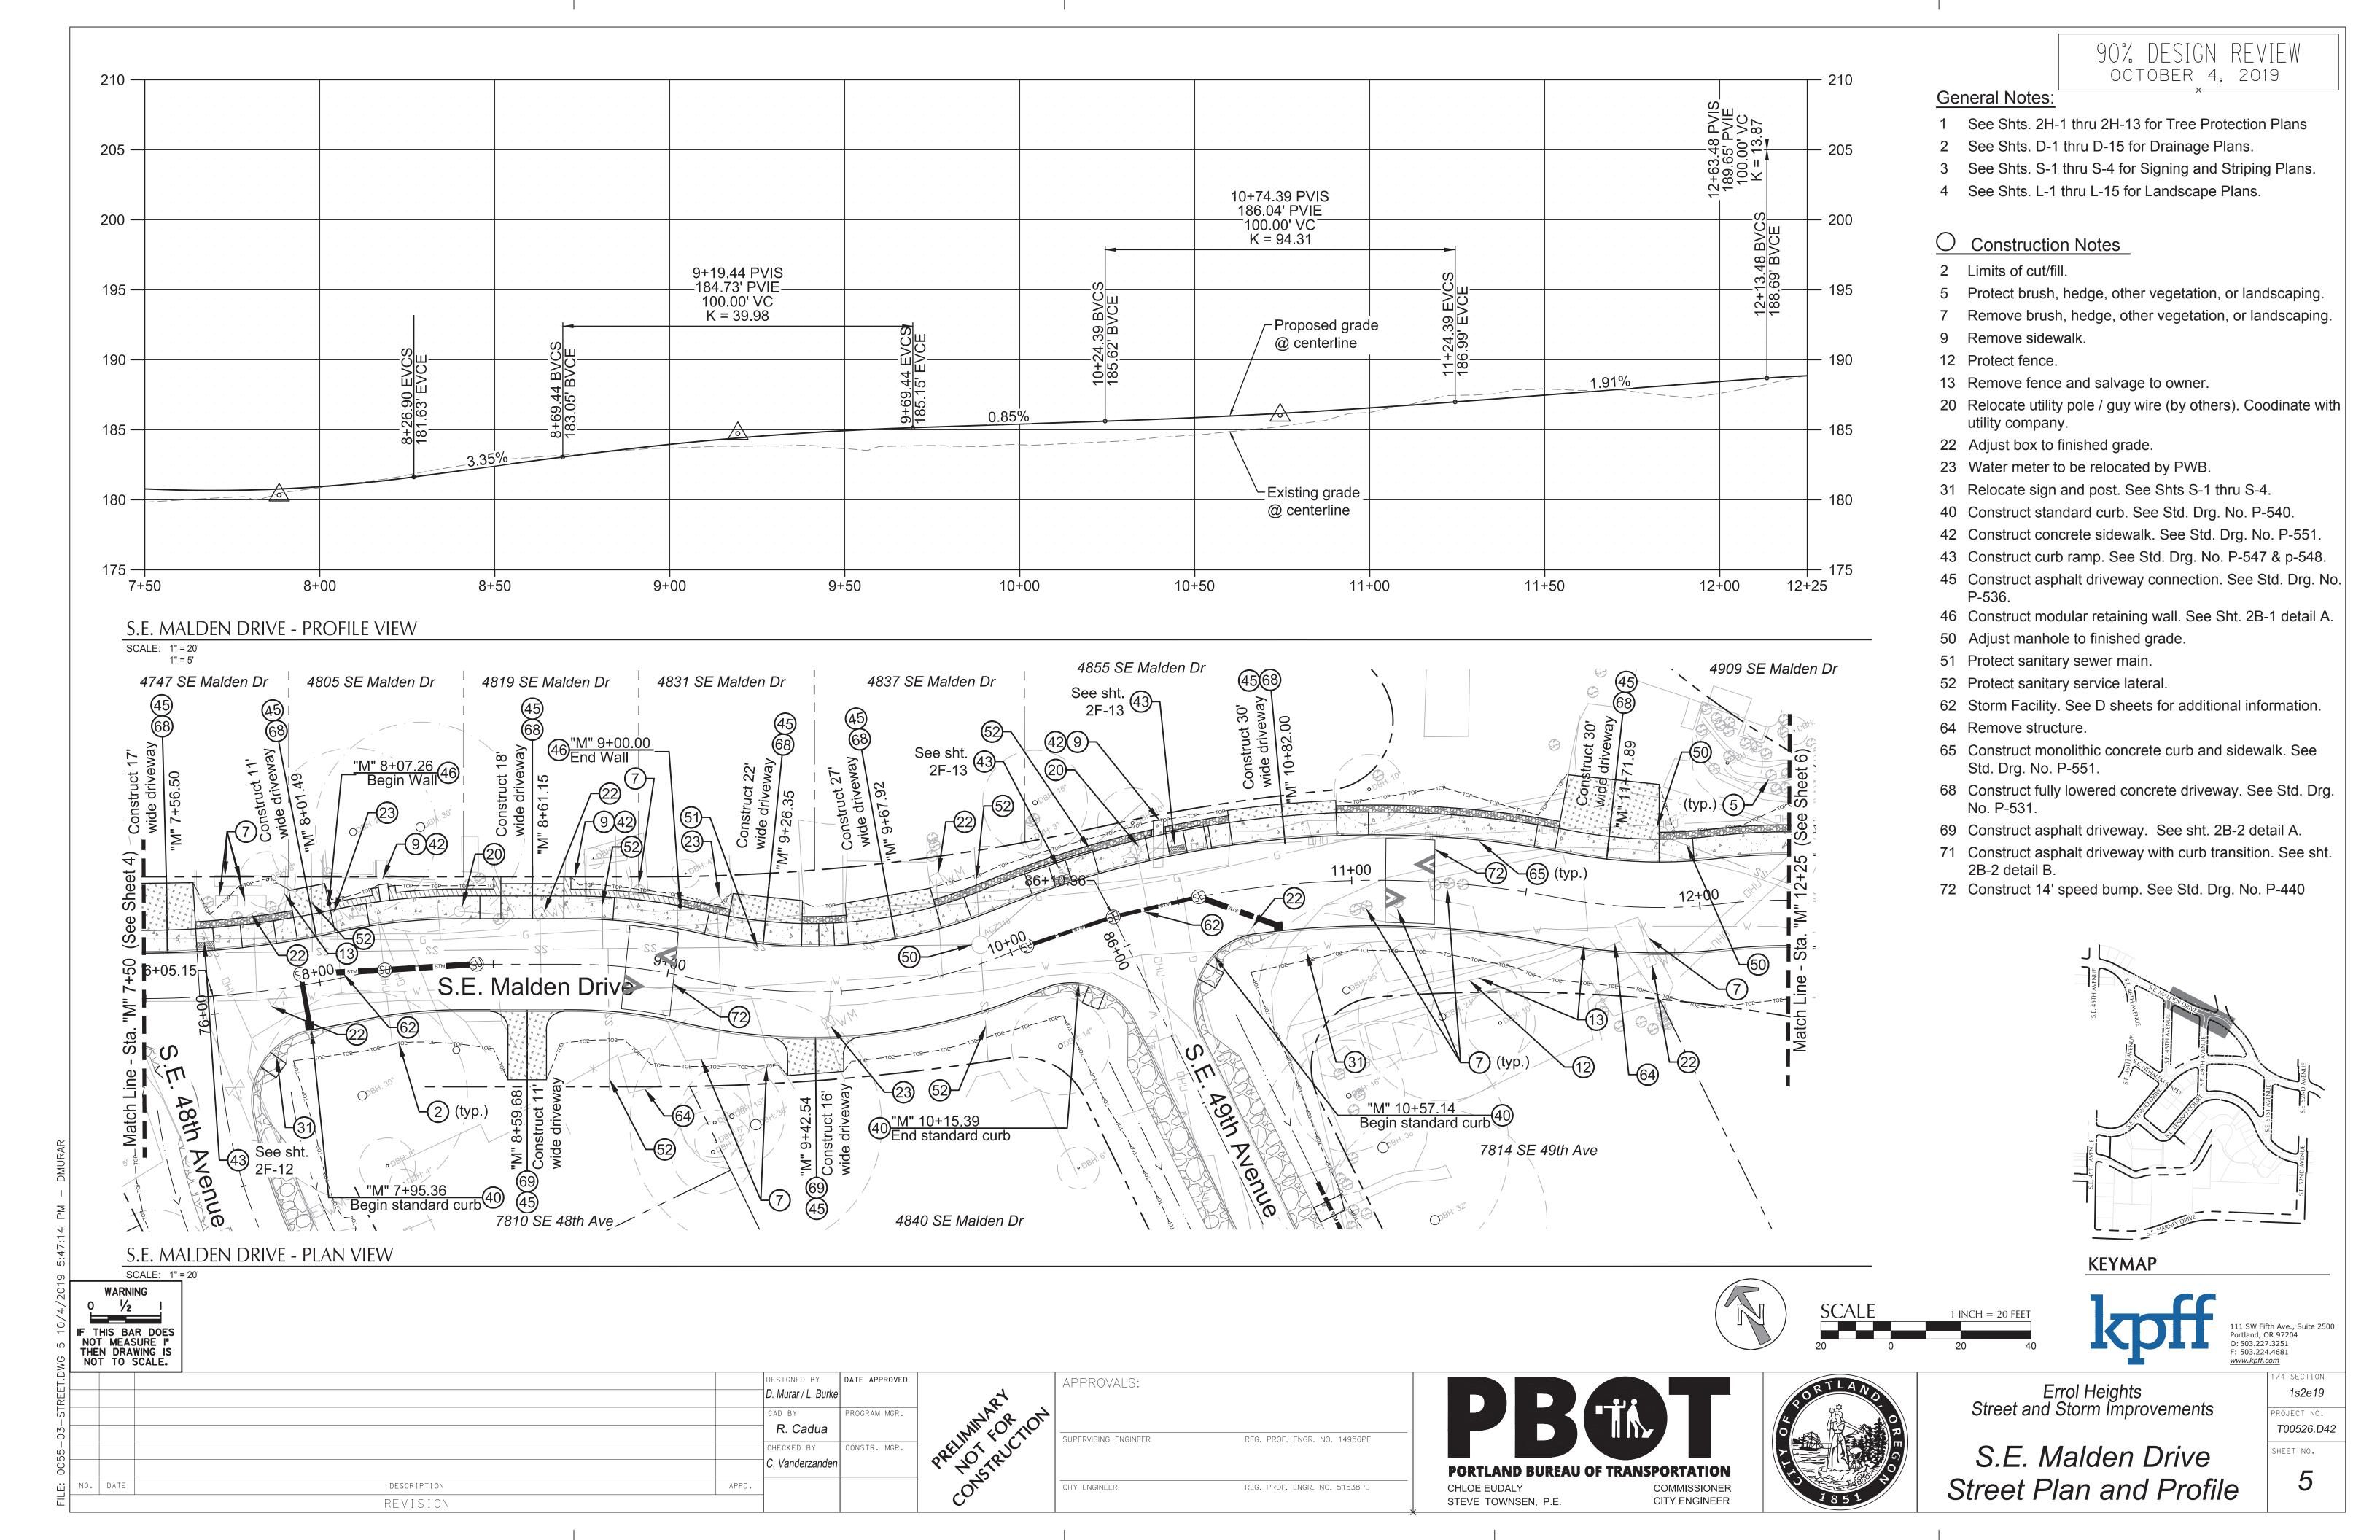

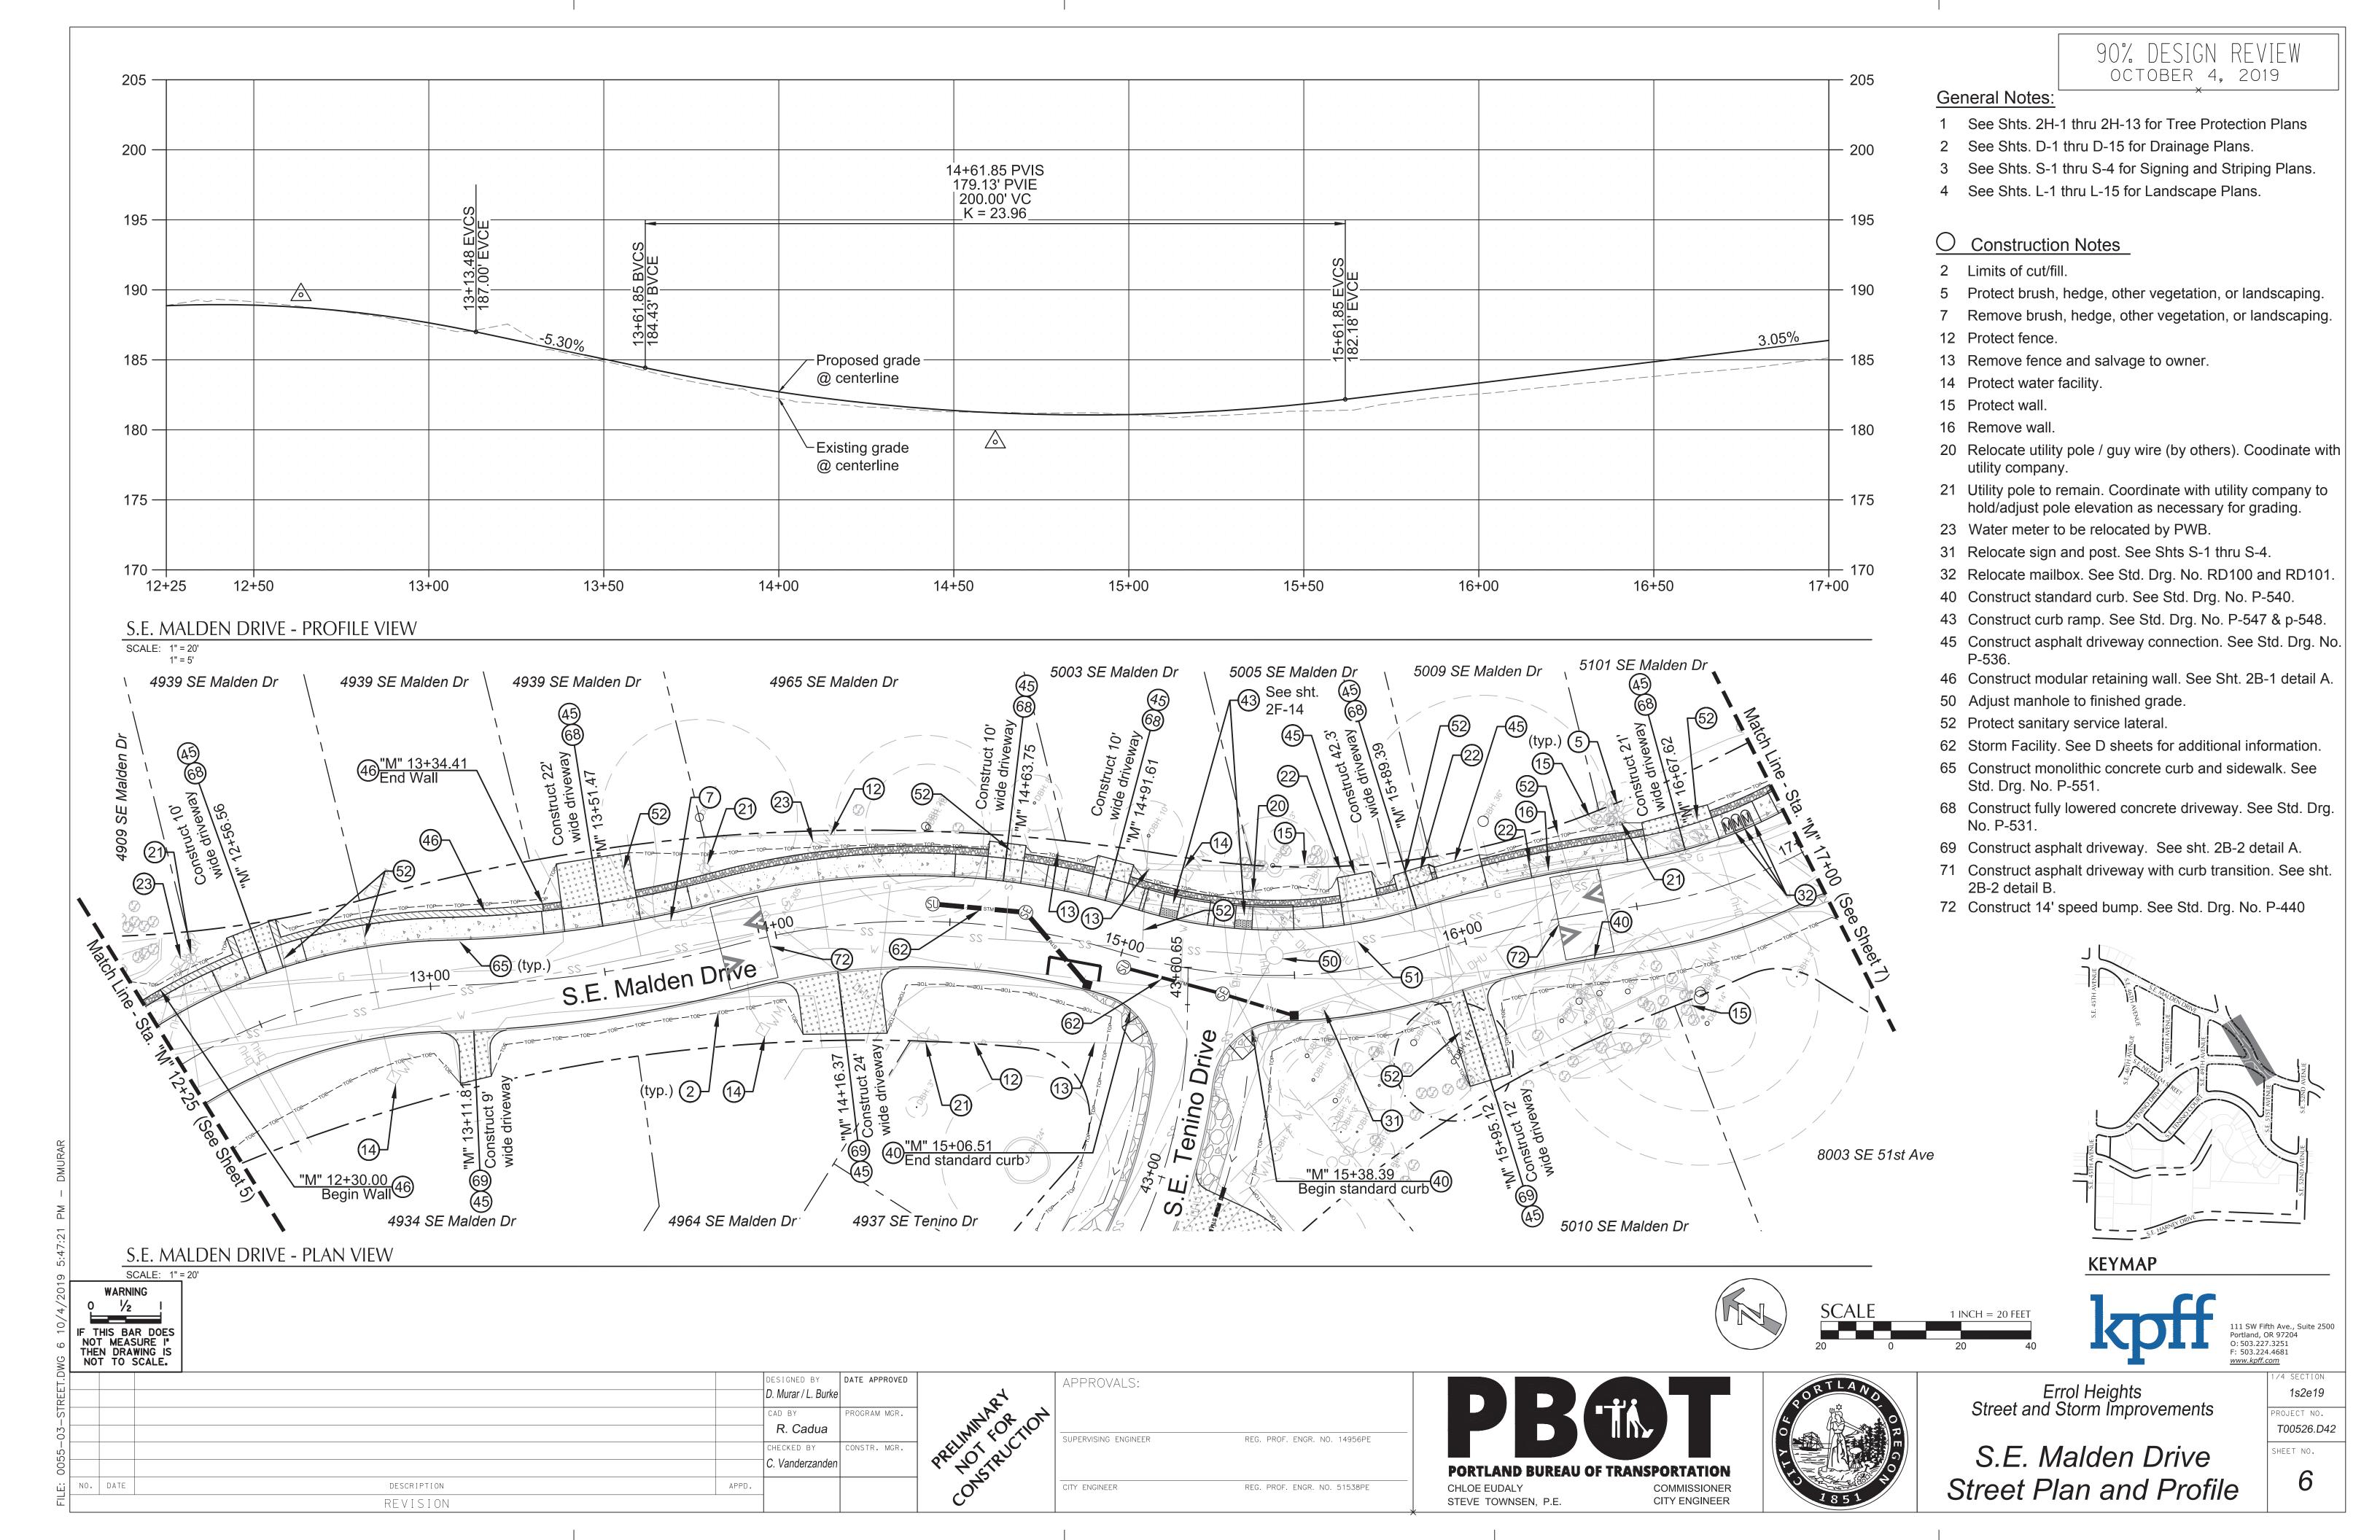



DESIGNED BY

D. Murar / L. Burke

R. Cadua

C. Vanderzander

CHECKED BY

APPD.

ROGRAM MGR.

End standard curb

DESCRIPTION

REVISION

S.E. MALDEN DRIVE - PLAN VIEW

SCALE: 1" = 20'

IF THIS BAR DOES NOT MEASURE I' THEN DRAWING IS NOT TO SCALE.

NO. DATE


90% DESIGN REVIEW OCTOBER 4, 2019

### **General Notes:**

- 1 See Shts. 2H-1 thru 2H-13 for Tree Protection Plans
- 2 See Shts. D-1 thru D-15 for Drainage Plans.
- 3 See Shts. S-1 thru S-4 for Signing and Striping Plans.
- 4 See Shts. L-1 thru L-15 for Landscape Plans.

### O Construction Notes

- 2 Limits of cut/fill.
- 3 Sawcut pavement.
- 7 Remove brush, hedge, other vegetation, or landscaping.
- 8 Remove curb.
- 15 Protect wall.
- 16 Remove wall.
- 20 Relocate utility pole / guy wire (by others). Coodinate with utility company.
- 22 Adjust box to finished grade.
- 23 Water meter to be relocated by PWB.
- 31 Relocate sign and post. See Shts S-1 thru S-4.
- 32 Relocate mailbox. See Std. Drg. No. RD100 and RD101.
- 40 Construct standard curb. See Std. Drg. No. P-540.
- 43 Construct curb ramp. See Std. Drg. No. P-547 & p-548.
- 45 Construct asphalt driveway connection. See Std. Drg. No. P-536.
- 50 Adjust manhole to finished grade.
- 51 Protect sanitary sewer main.
- 52 Protect sanitary service lateral.
- 65 Construct monolithic concrete curb and sidewalk. See Std. Drg. No. P-551.
- 66 Construct end of sidewalk transition. See Std. Drg. No. RD754.
- 68 Construct fully lowered concrete driveway. See Std. Drg. No. P-531.
- 69 Construct asphalt driveway. See sht. 2B-2 detail A.
- 71 Construct asphalt driveway with curb transition. See sht. 2B-2 detail B.
- 72 Construct 14' speed bump. See Std. Drg. No. P-440

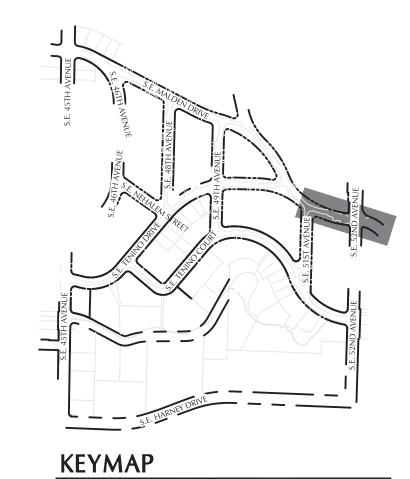





Portland, OR 97204 O: 503.227.3251 F: 503.224.4681 www.kpff.com Errol Heights
Street and Storm Improvements


1s2e19

T00526.D42

SHEET NO.

S.E. Malden Drive

Street Plan and Profile

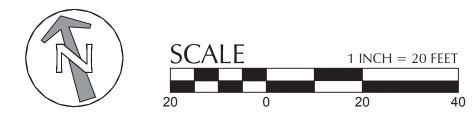

APPROVALS:

RT 13.00' RT 14.08'


8015 SE 52nd Ave \


UPERVISING ENGINEER REG. PROF. ENGR. NO. 14956PE REG. PROF. ENGR. NO. 51538PE CITY ENGINEER


Avenue

**PORTLAND BUREAU OF TRANSPORTATION** CHLOE EUDALY COMMISSIONER CITY ENGINEER


STEVE TOWNSEN, P.E.

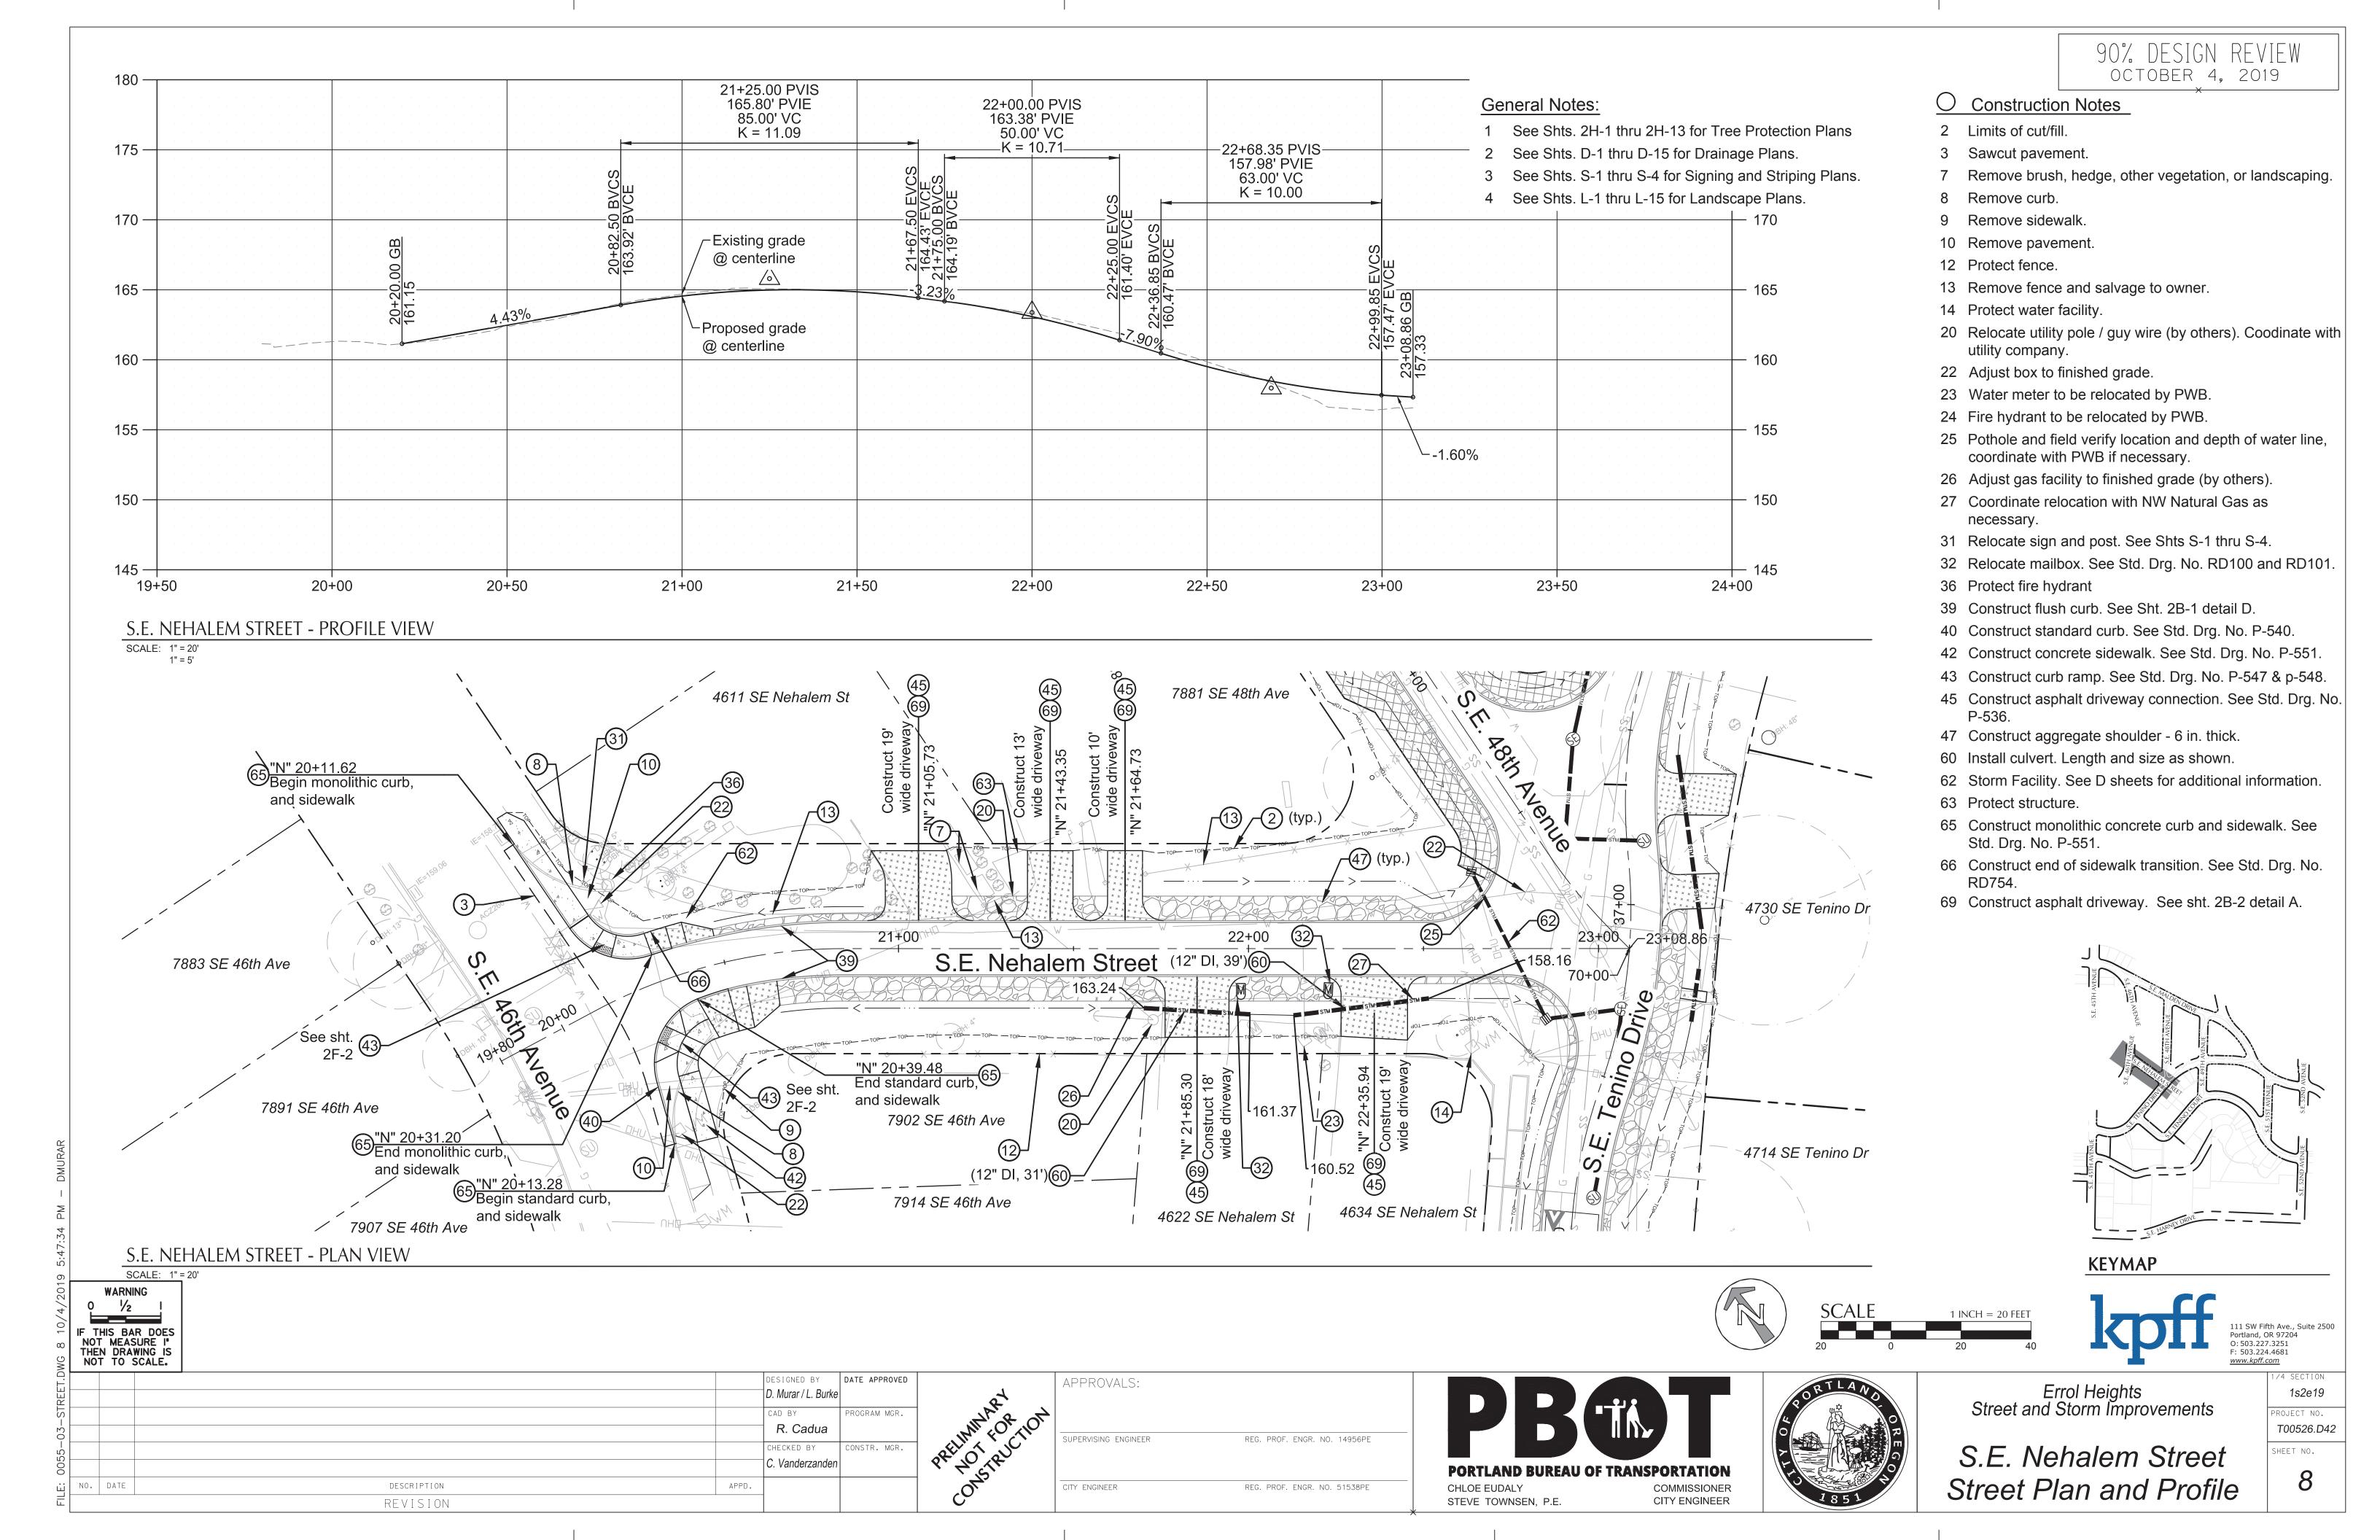

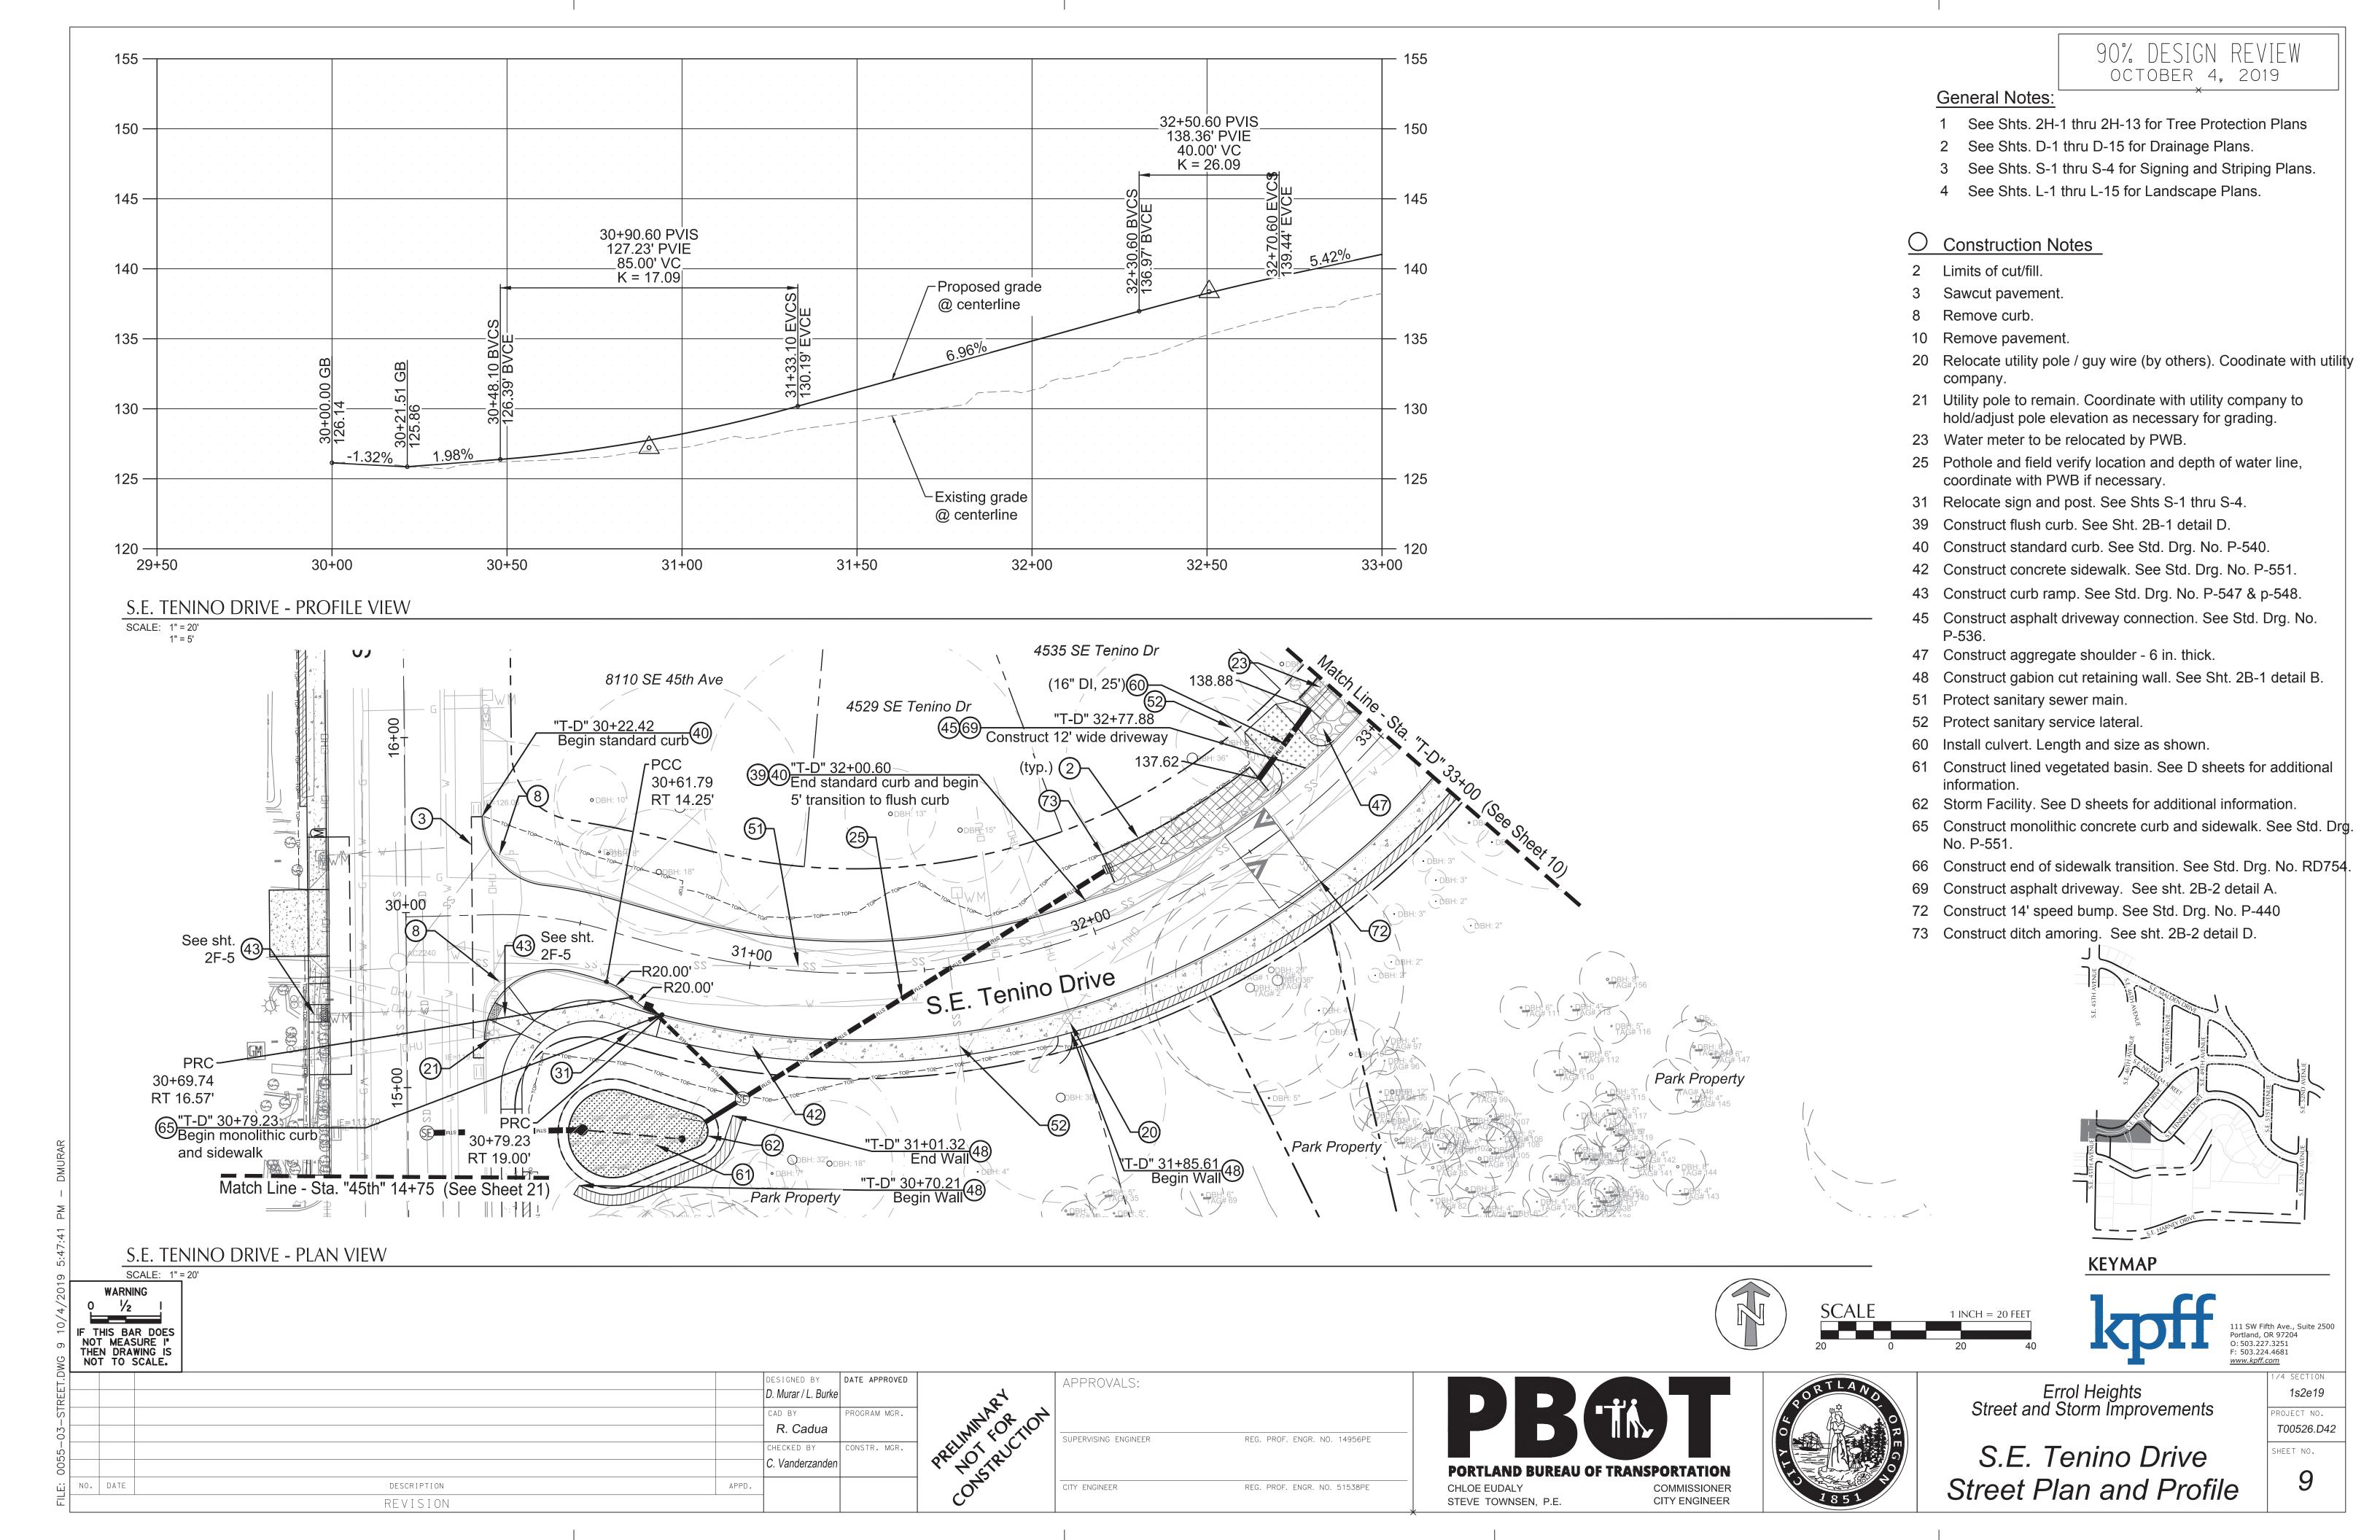

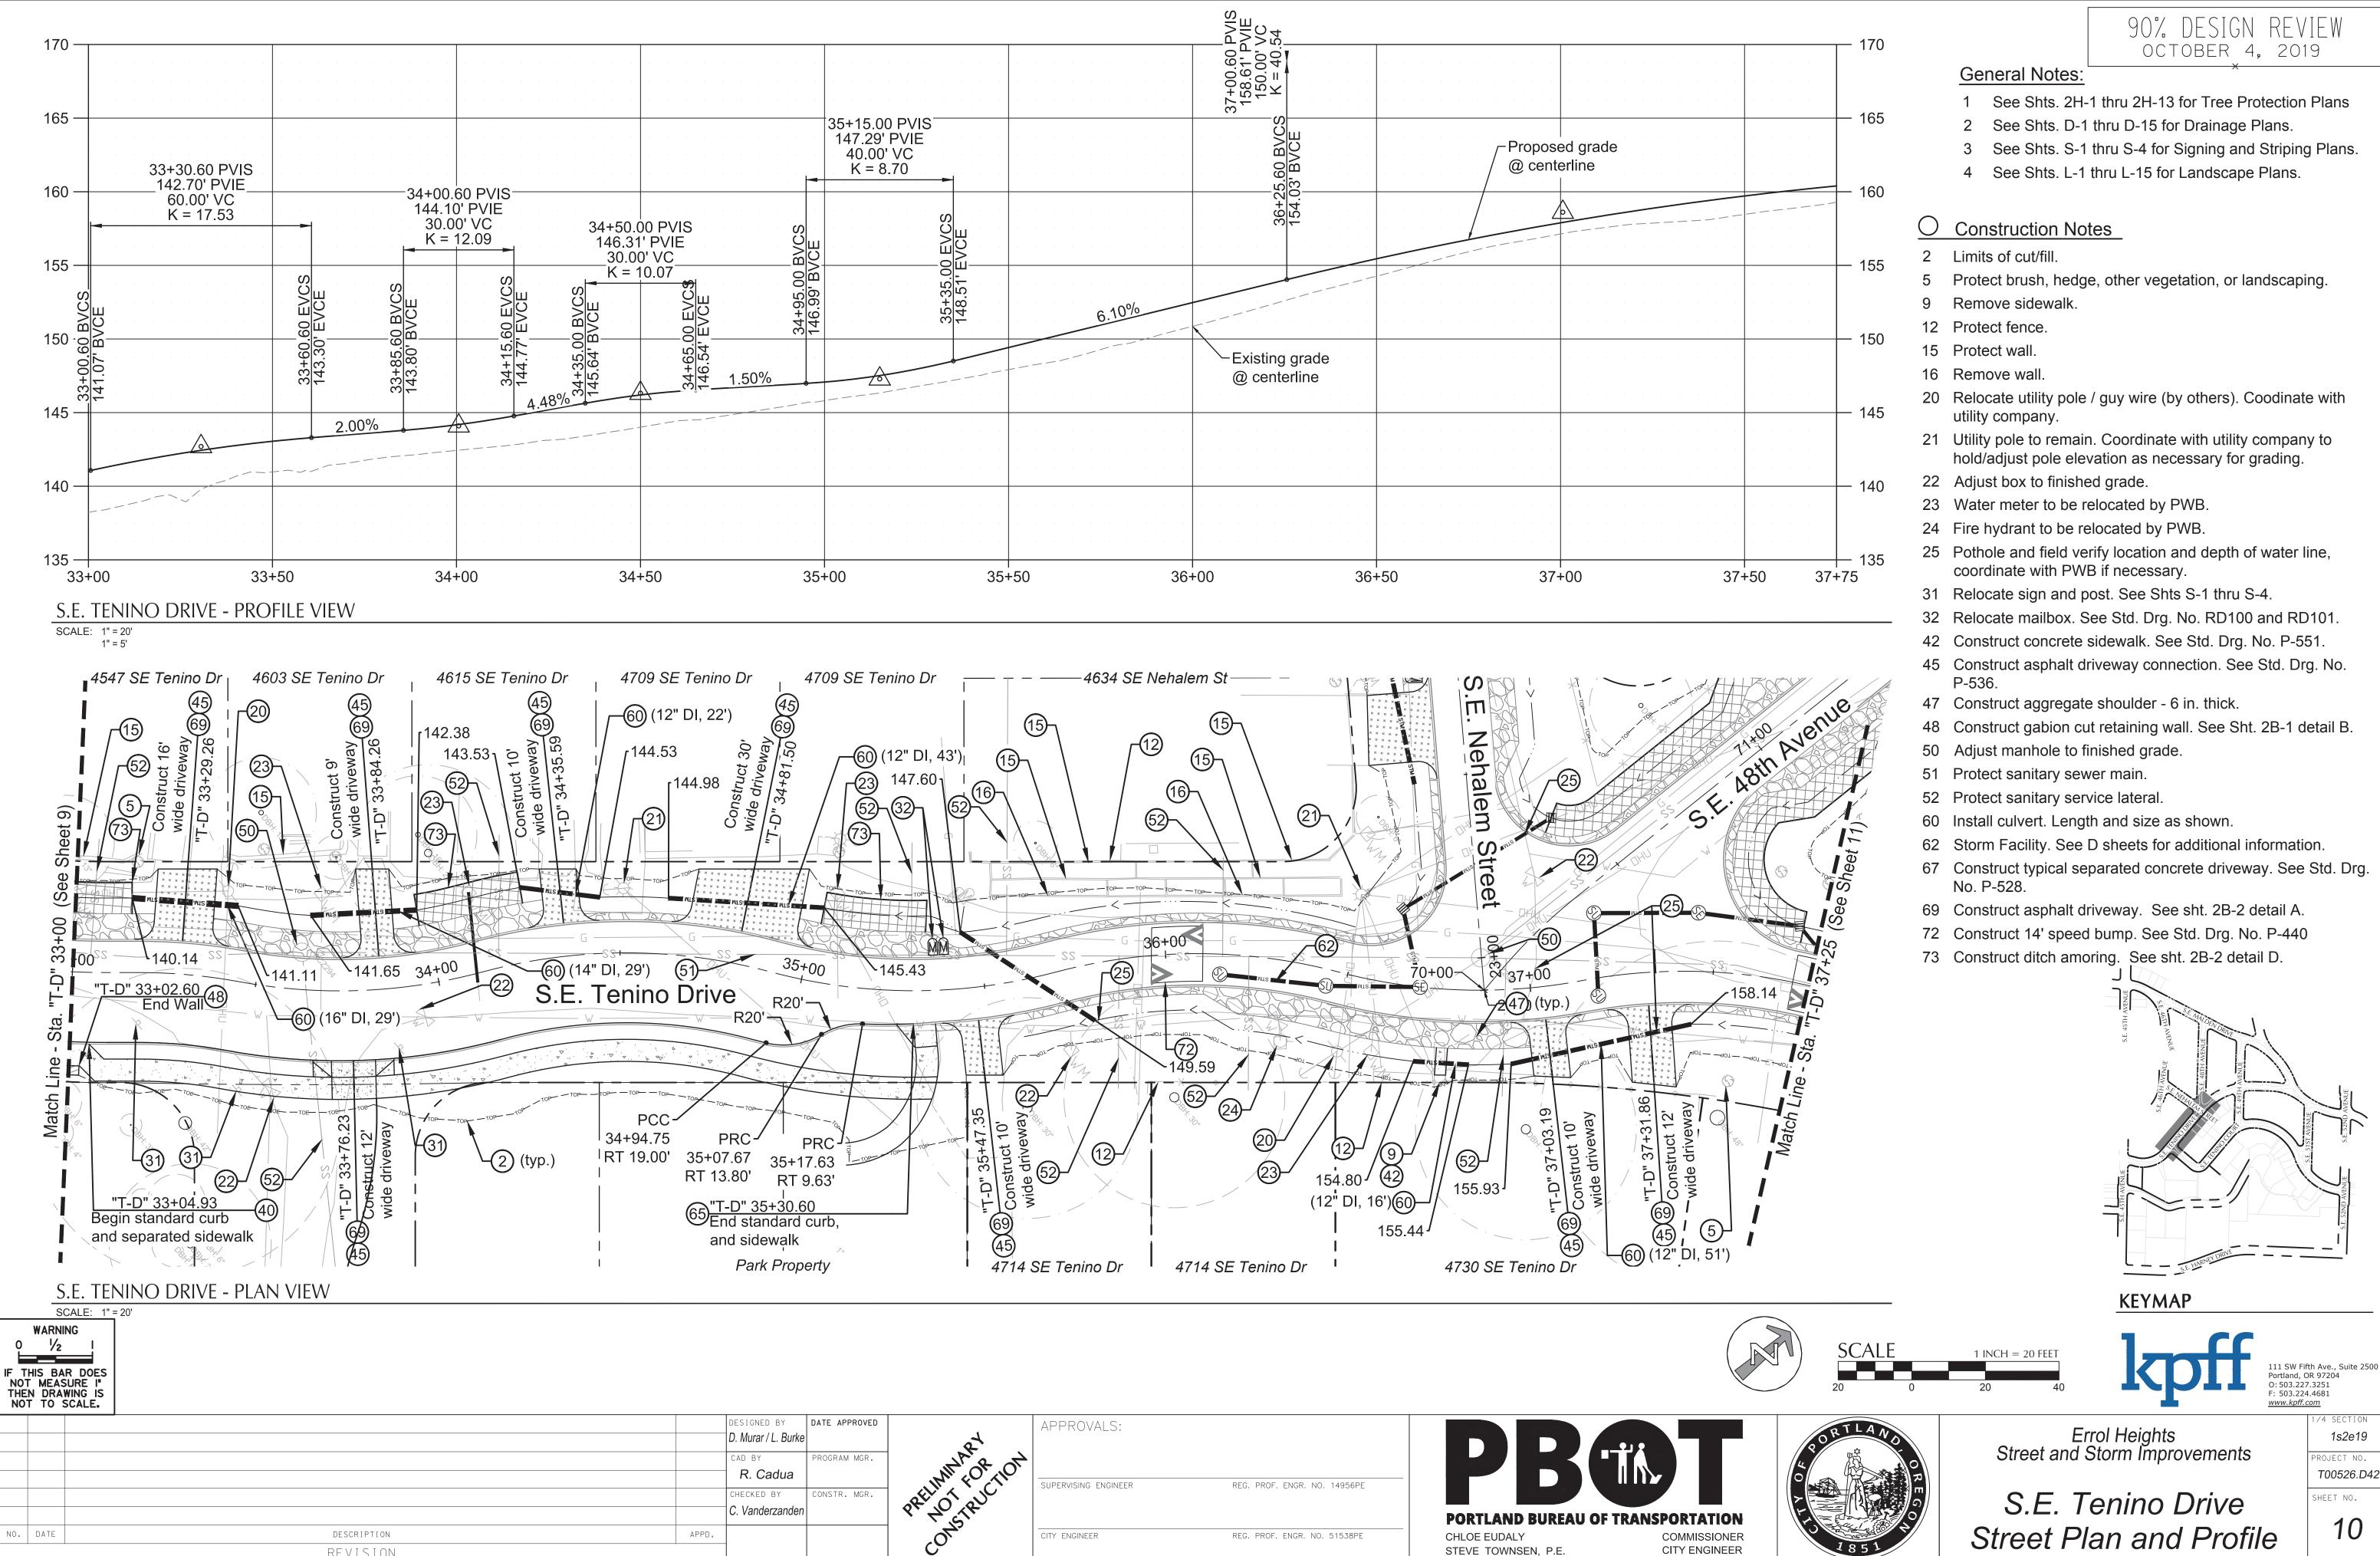

REVISION

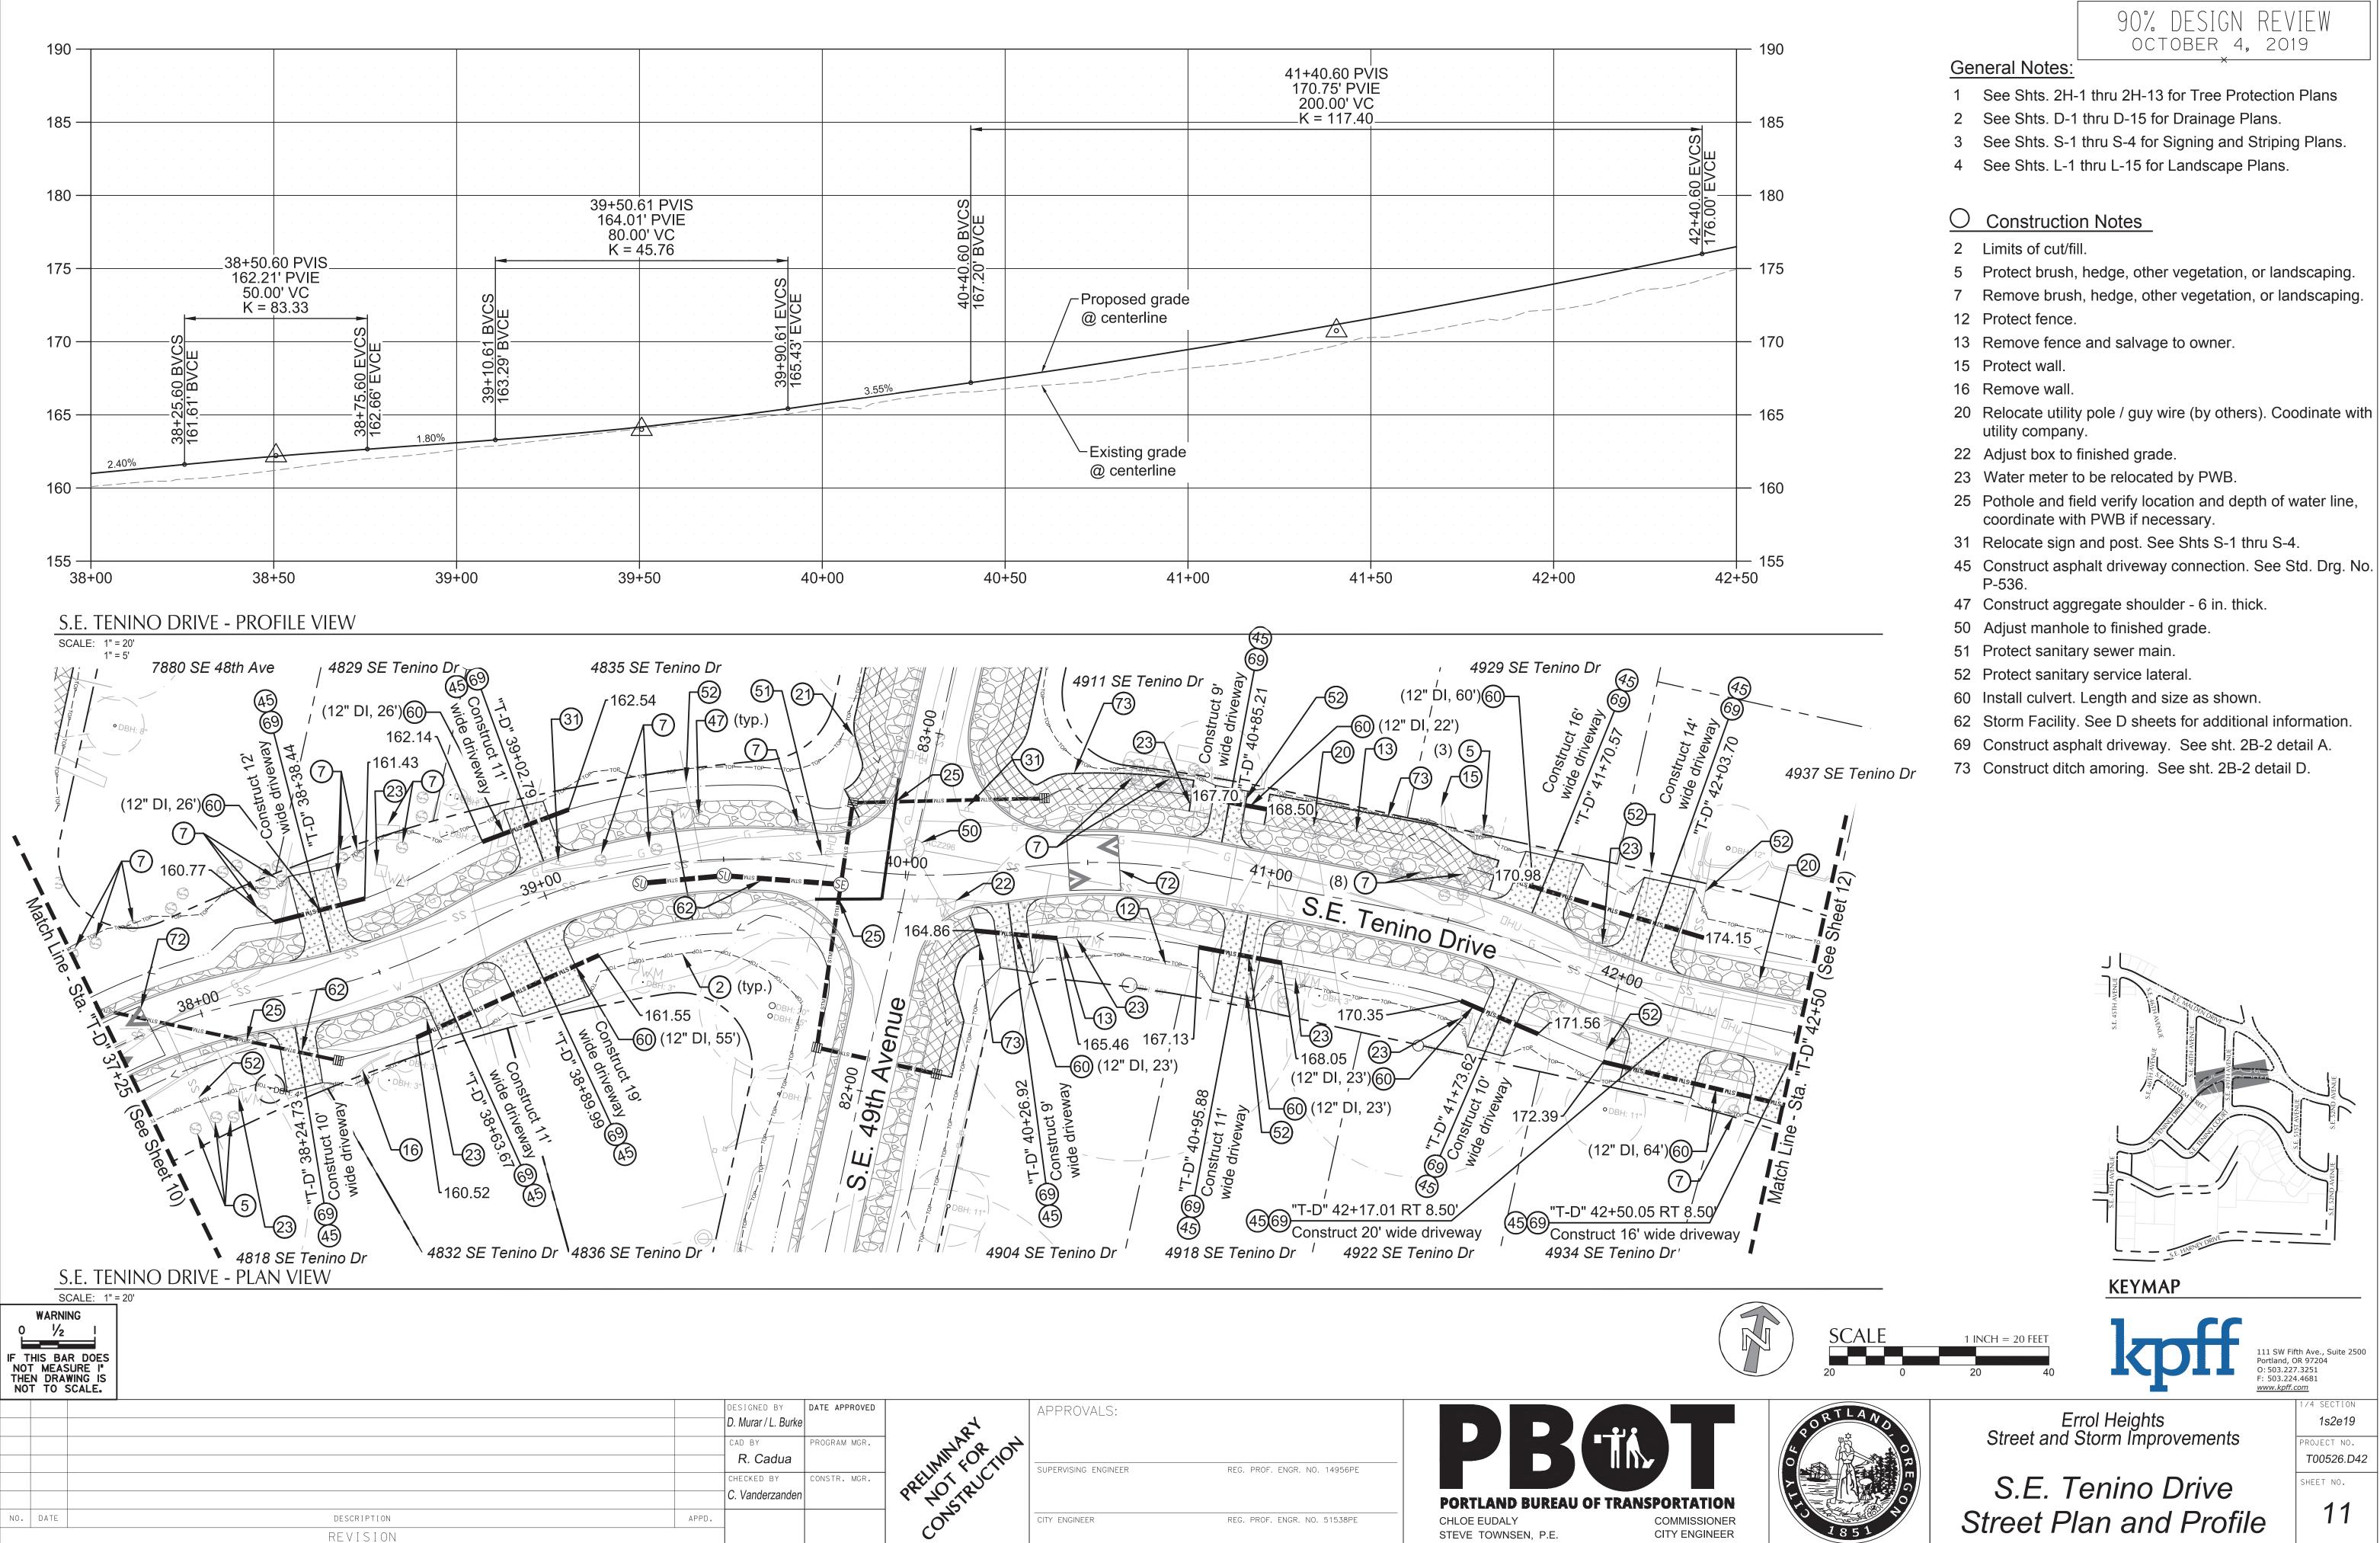

OCTOBER 4, 2019 200 General Notes: 43+30.00 PVIS 180.70' PVIE 30.00' VC 1 See Shts. 2H-1 thru 2H-13 for Tree Protection Plans 2 See Shts. D-1 thru D-15 for Drainage Plans. 195 195 -K = 9.23-3 See Shts. S-1 thru S-4 for Signing and Striping Plans. 4 See Shts. L-1 thru L-15 for Landscape Plans. 43+45.00 EVCS 181.00' EVCE 190 -190 43+15.00 BVCs 179.91' BVCE O Construction Notes Proposed grade ¬ 7 43+60.65 GB 2 Limits of cut/fill. @ centerline 181.31 185 -185 7 Remove brush, hedge, other vegetation, or landscaping. 12 Protect fence. 13 Remove fence and salvage to owner. 180 180 20 Relocate utility pole / guy wire (by others). Coodinate with utility company. **-2.00%** 22 Adjust box to finished grade. 23 Water meter to be relocated by PWB. - 175 24 Fire hydrant to be relocated by PWB. Existing grade 25 Pothole and field verify location and depth of water line, @ centerline coordinate with PWB if necessary. 170 -- 170 45 Construct asphalt driveway connection. See Std. Drg. No. 47 Construct aggregate shoulder - 6 in. thick. 51 Protect sanitary sewer main. 165 — - 165 42+50 43+00 43+50 44+00 44+50 52 Protect sanitary service lateral. 60 Install culvert. Length and size as shown. S.E. TENINO DRIVE - PROFILE VIEW 69 Construct asphalt driveway. See sht. 2B-2 detail A. SCALE: 1" = 20' 1" = 5' 72 Construct 14' speed bump. See Std. Drg. No. P-440 SE Malden 5003 SE Malden Dr 4937 SE Tenino Dr (typ.) 2 (typ.) 47 5007 SE Malden Dr 176.19 20 S.E. Tenino Drive 5005 SE Malden Dr 5009 SE Malden Dr 4942 SE Tenino Dr 5004 SE Tenino Dr S.E. TENINO DRIVE - PLAN VIEW **KEYMAP** SCALE: 1" = 20' 111 SW Fifth Ave., Suite 2500 Portland, OR 97204 O: 503.227.3251 F: 503.224.4681 www.kpff.com IF THIS BAR DOES NOT MEASURE I' THEN DRAWING IS NOT TO SCALE. APPROVALS: DESIGNED BY Errol Heights
Street and Storm Improvements 1s2e19 D. Murar / L. Burke PROJECT NO. CAD BY ROGRAM MGR. R. Cadua T00526.D42 SUPERVISING ENGINEER REG. PROF. ENGR. NO. 14956PE CHECKED BY S.E. Tenino Drive SHEET NO. C. Vanderzander DESCRIPTION NO. DATE APPD. CITY ENGINEER REG. PROF. ENGR. NO. 51538PE CHLOE EUDALY COMMISSIONER


REVISION


90% DESIGN REVIEW


Street Plan and Profile


CITY ENGINEER

STEVE TOWNSEN, P.E.

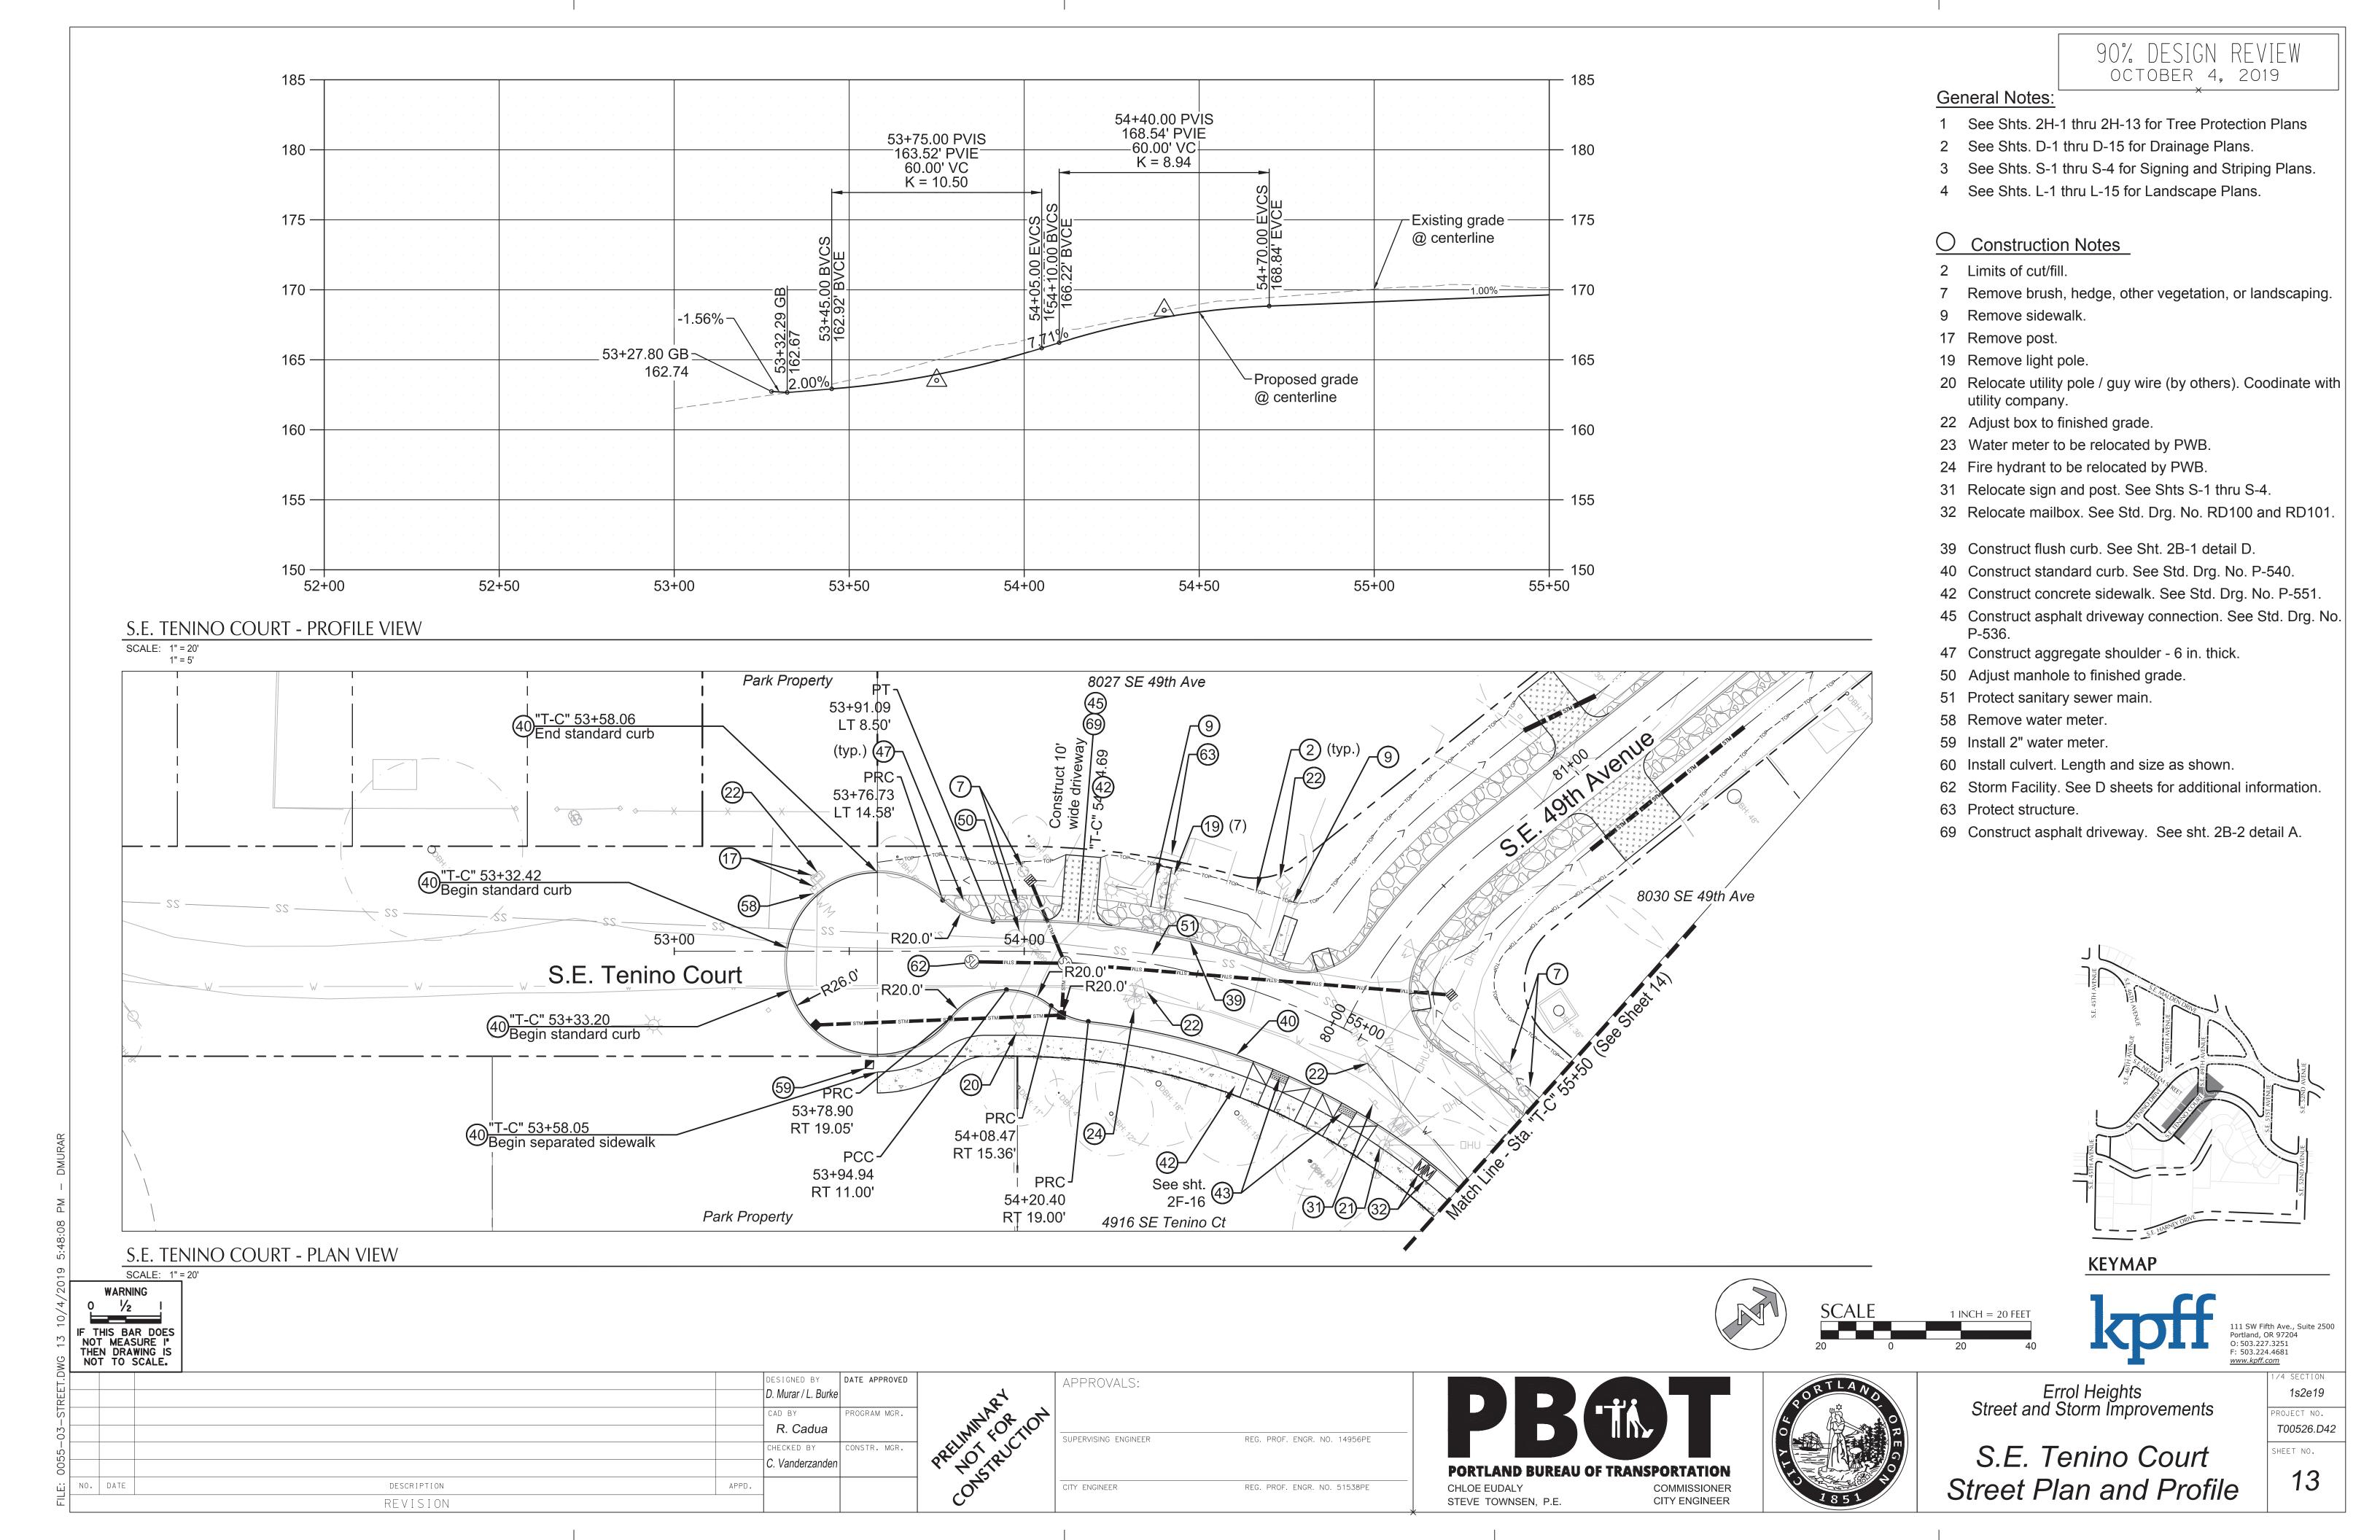

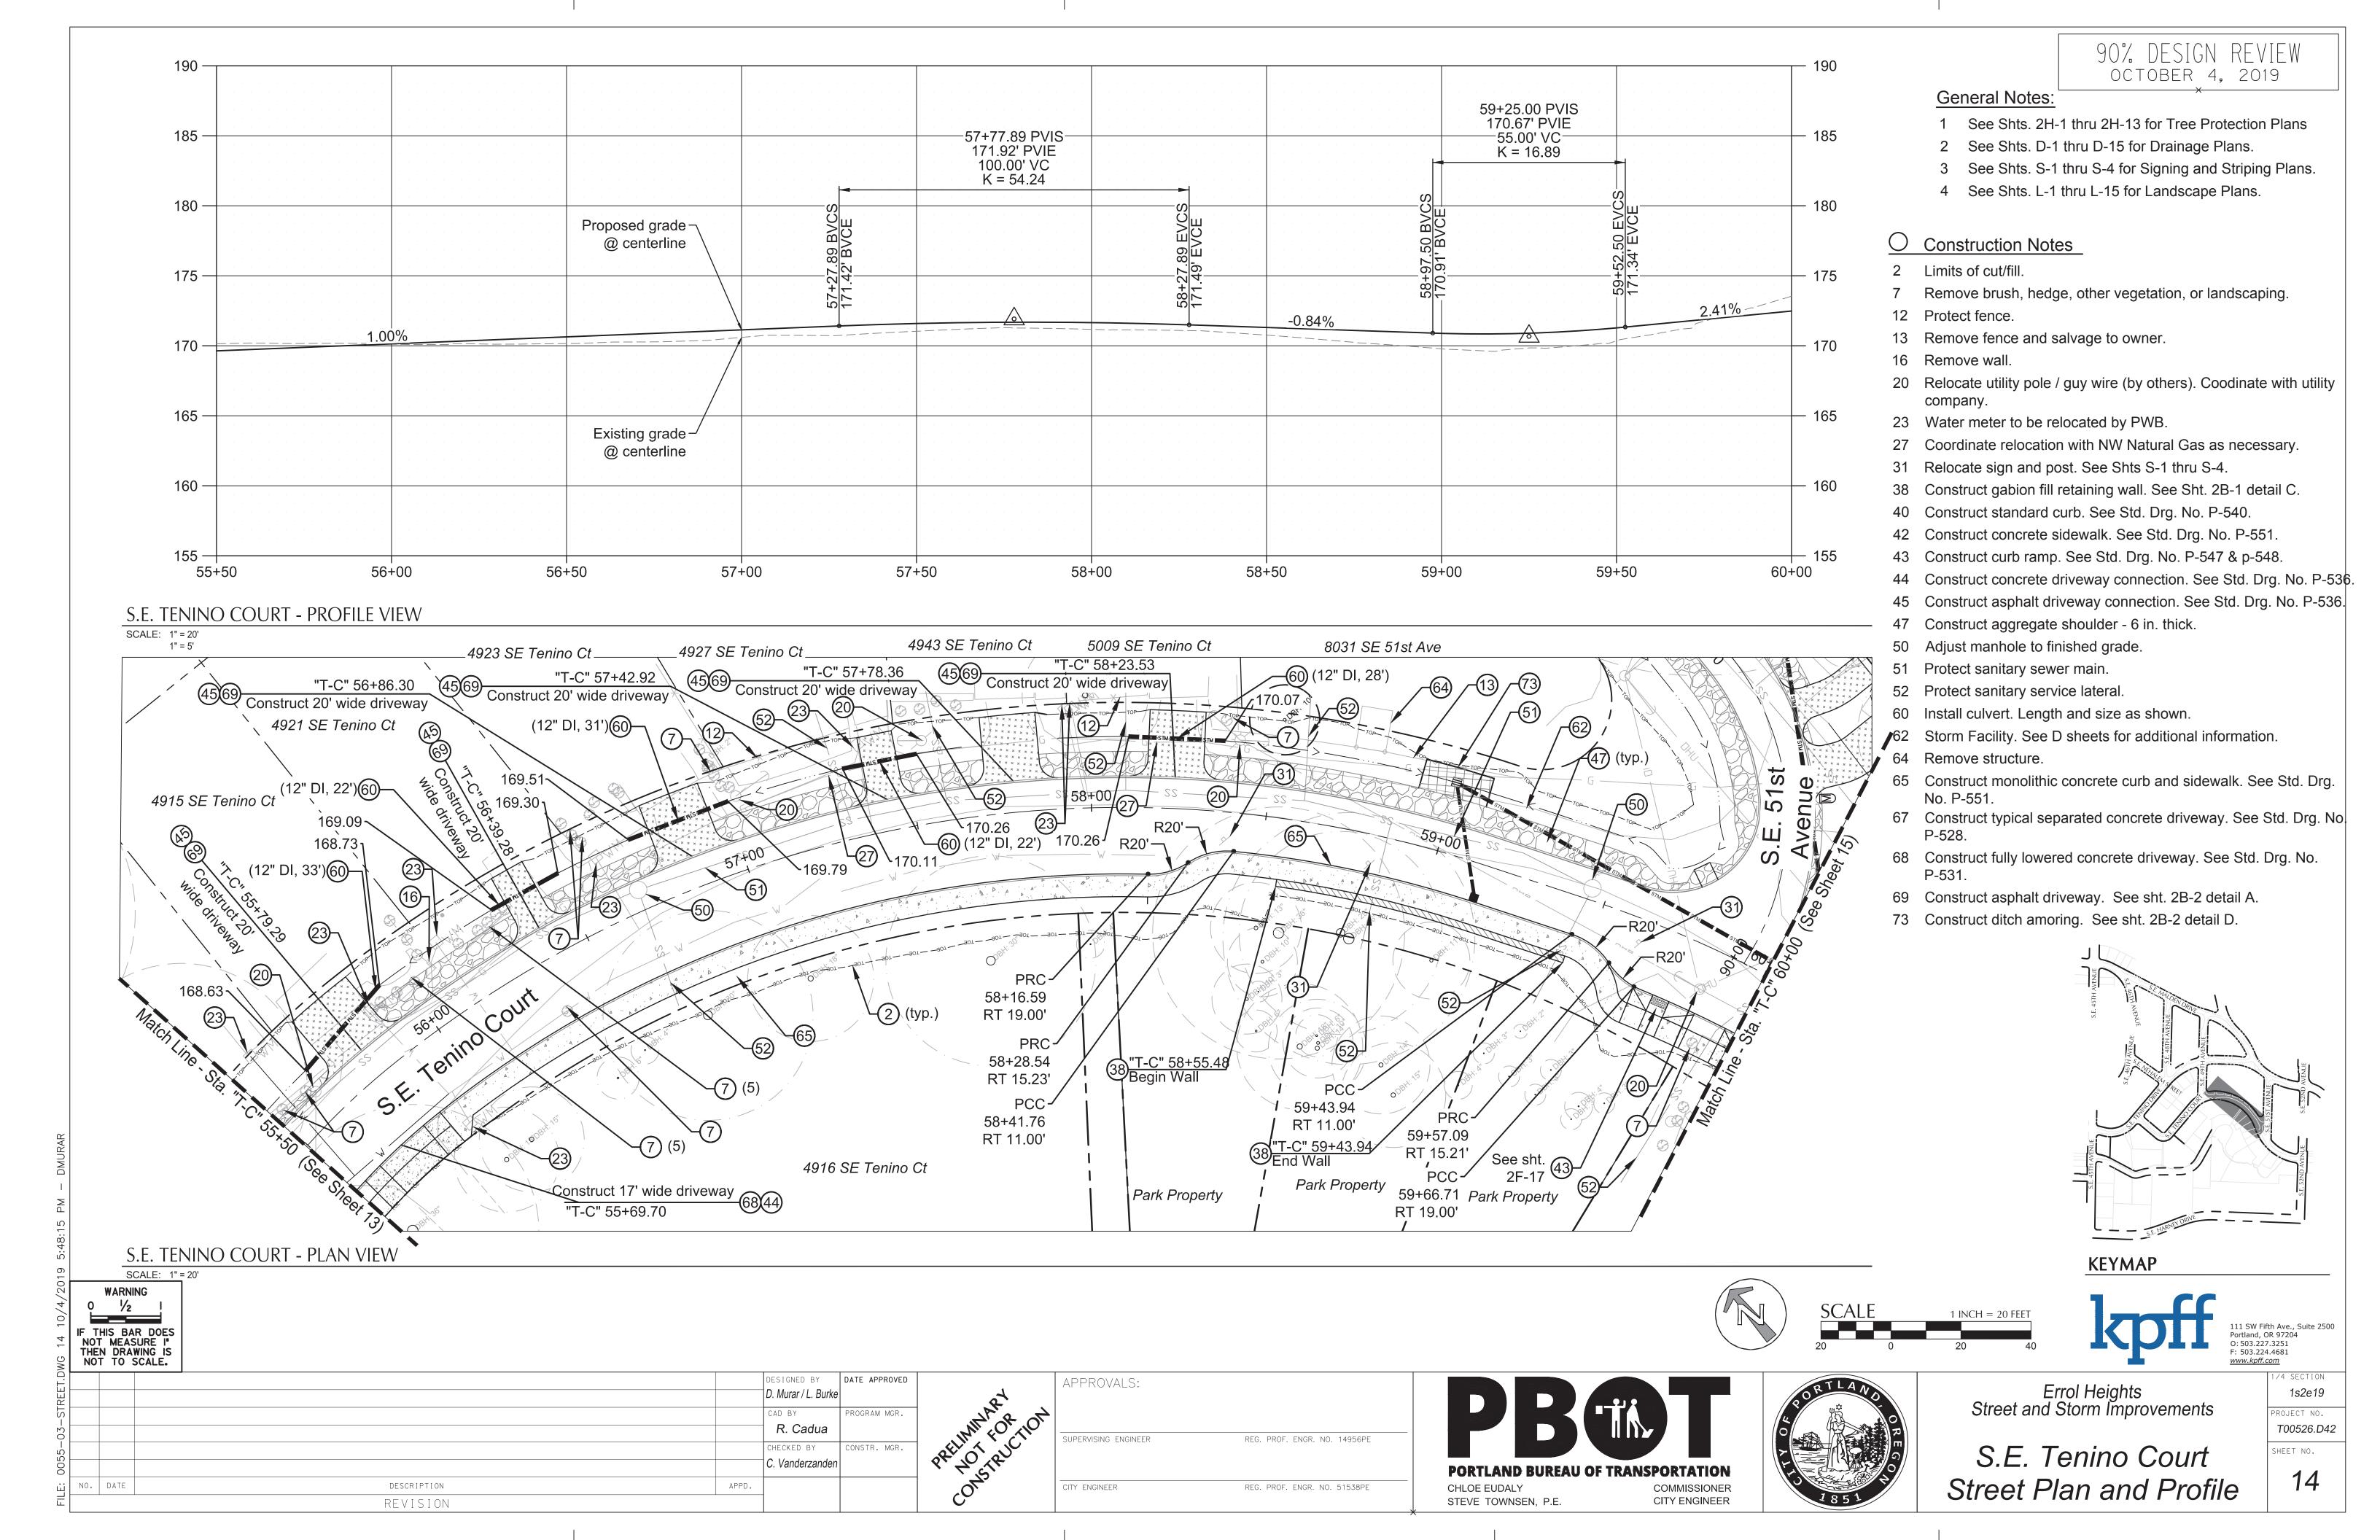

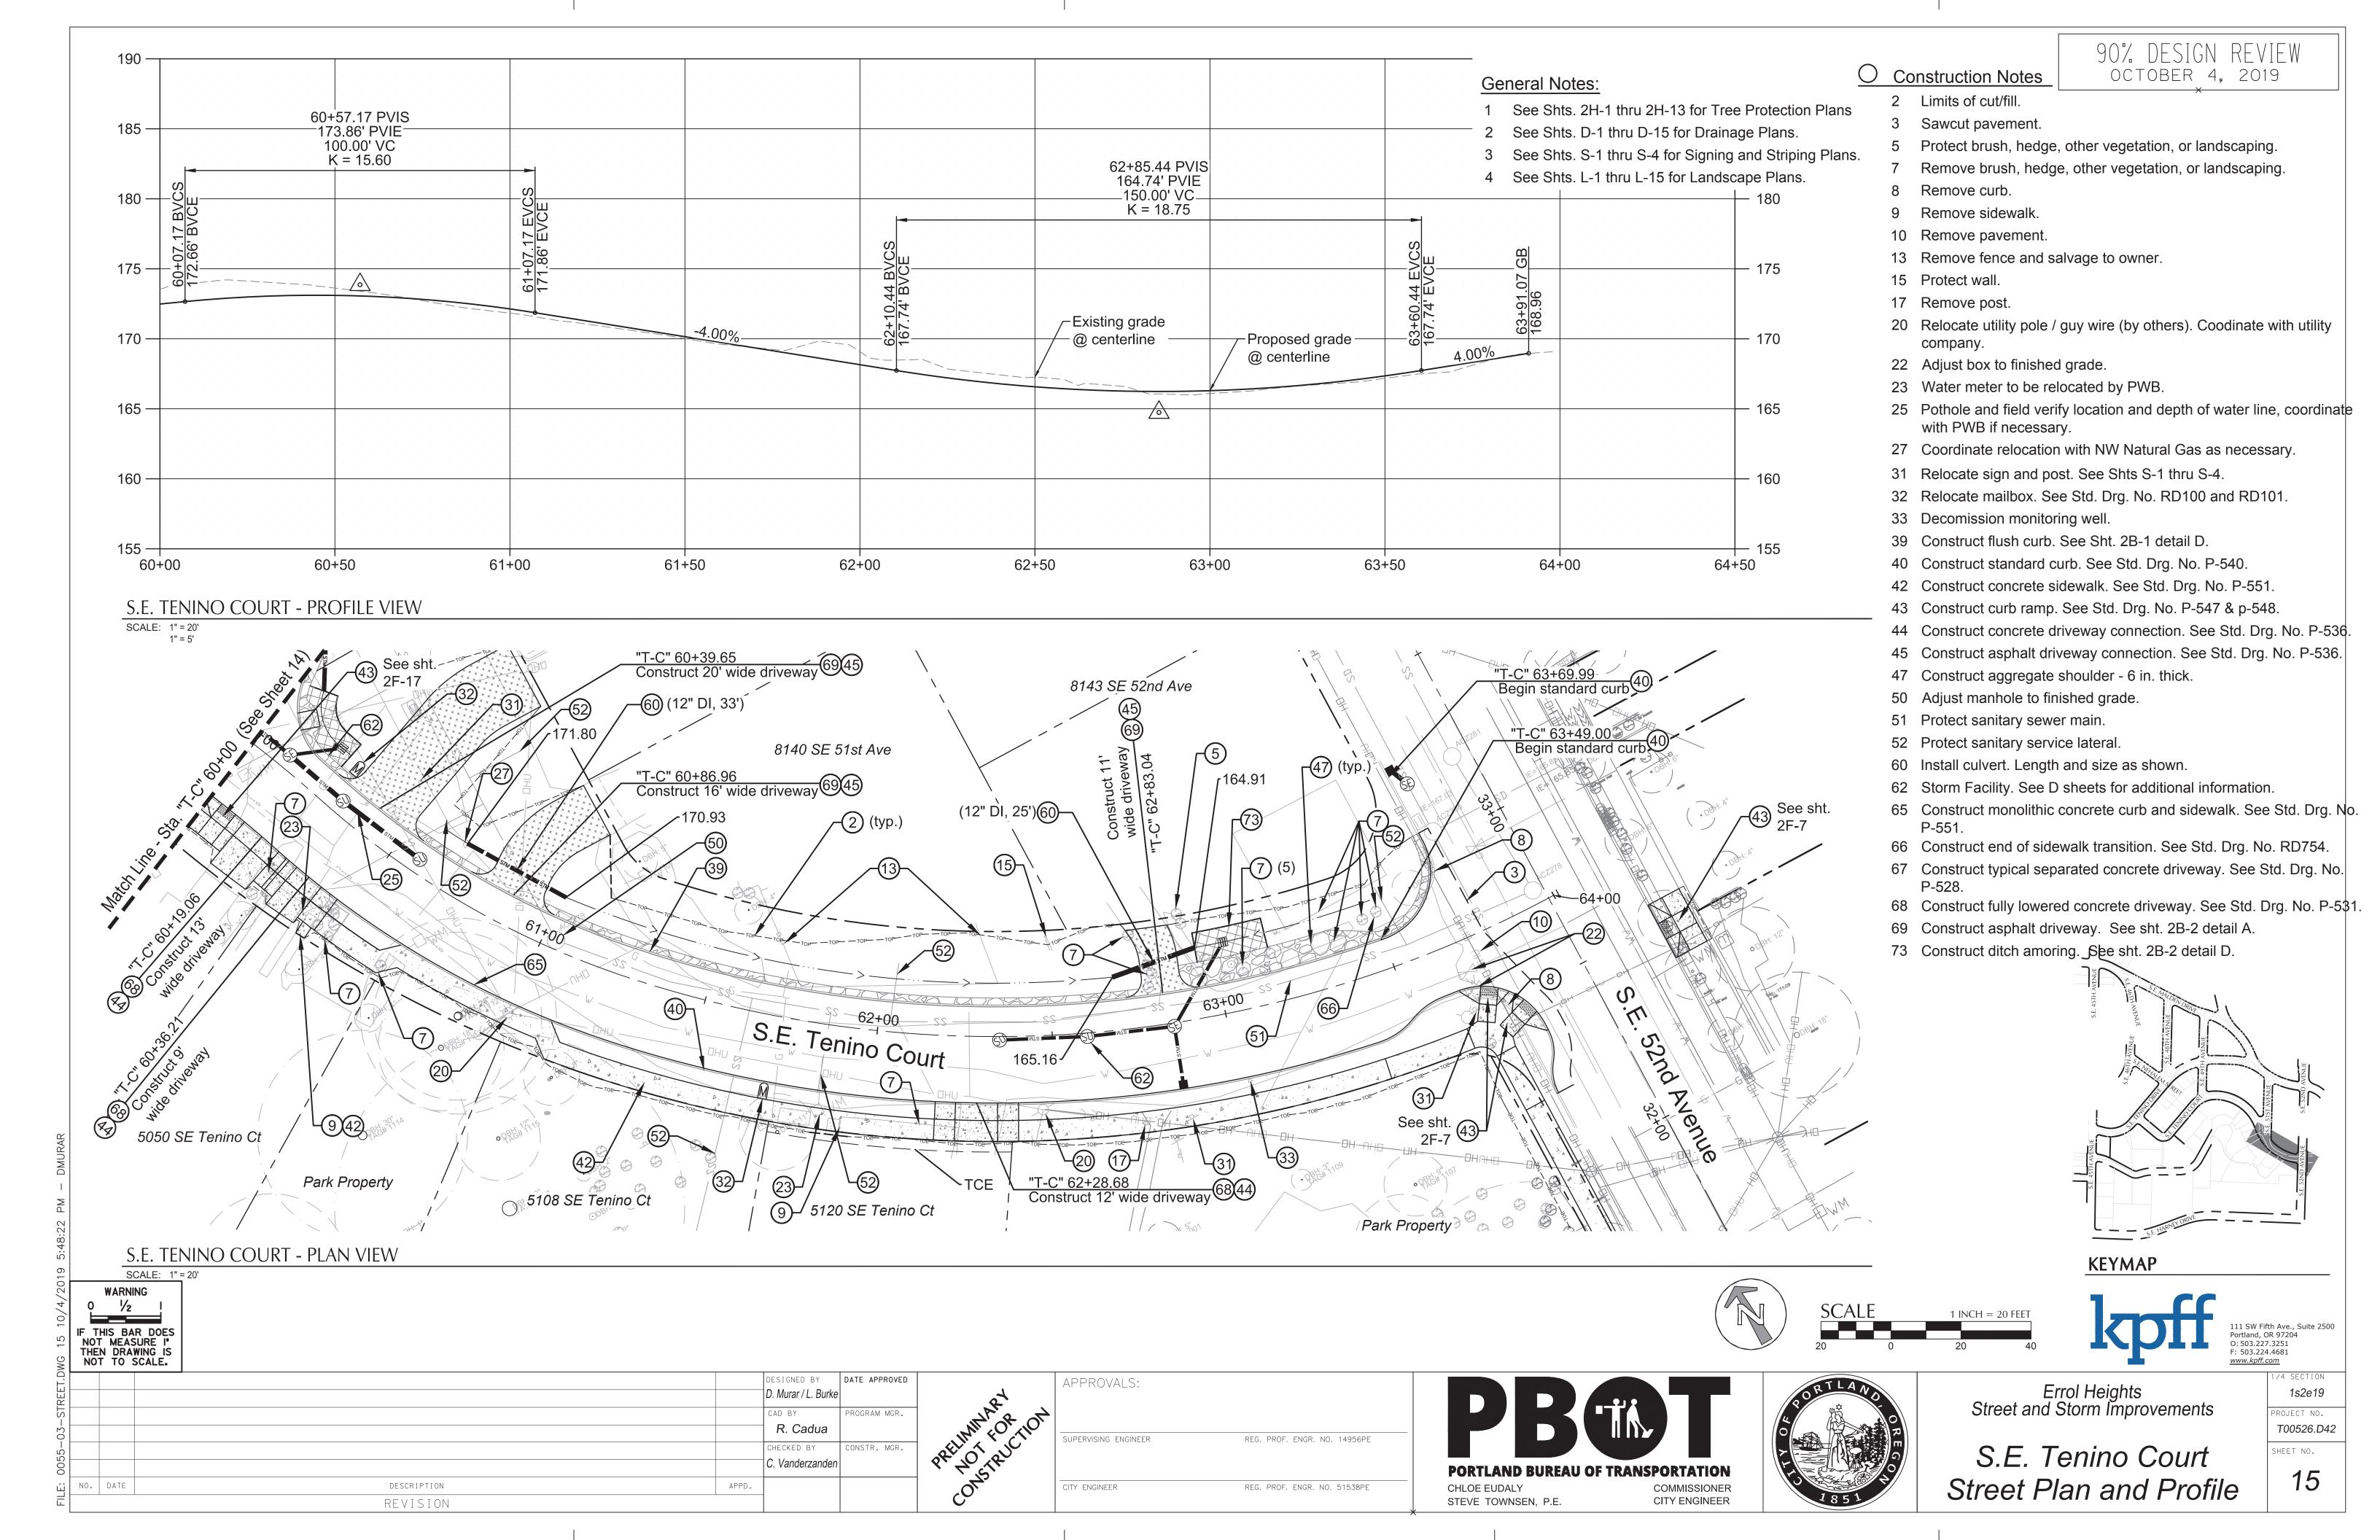

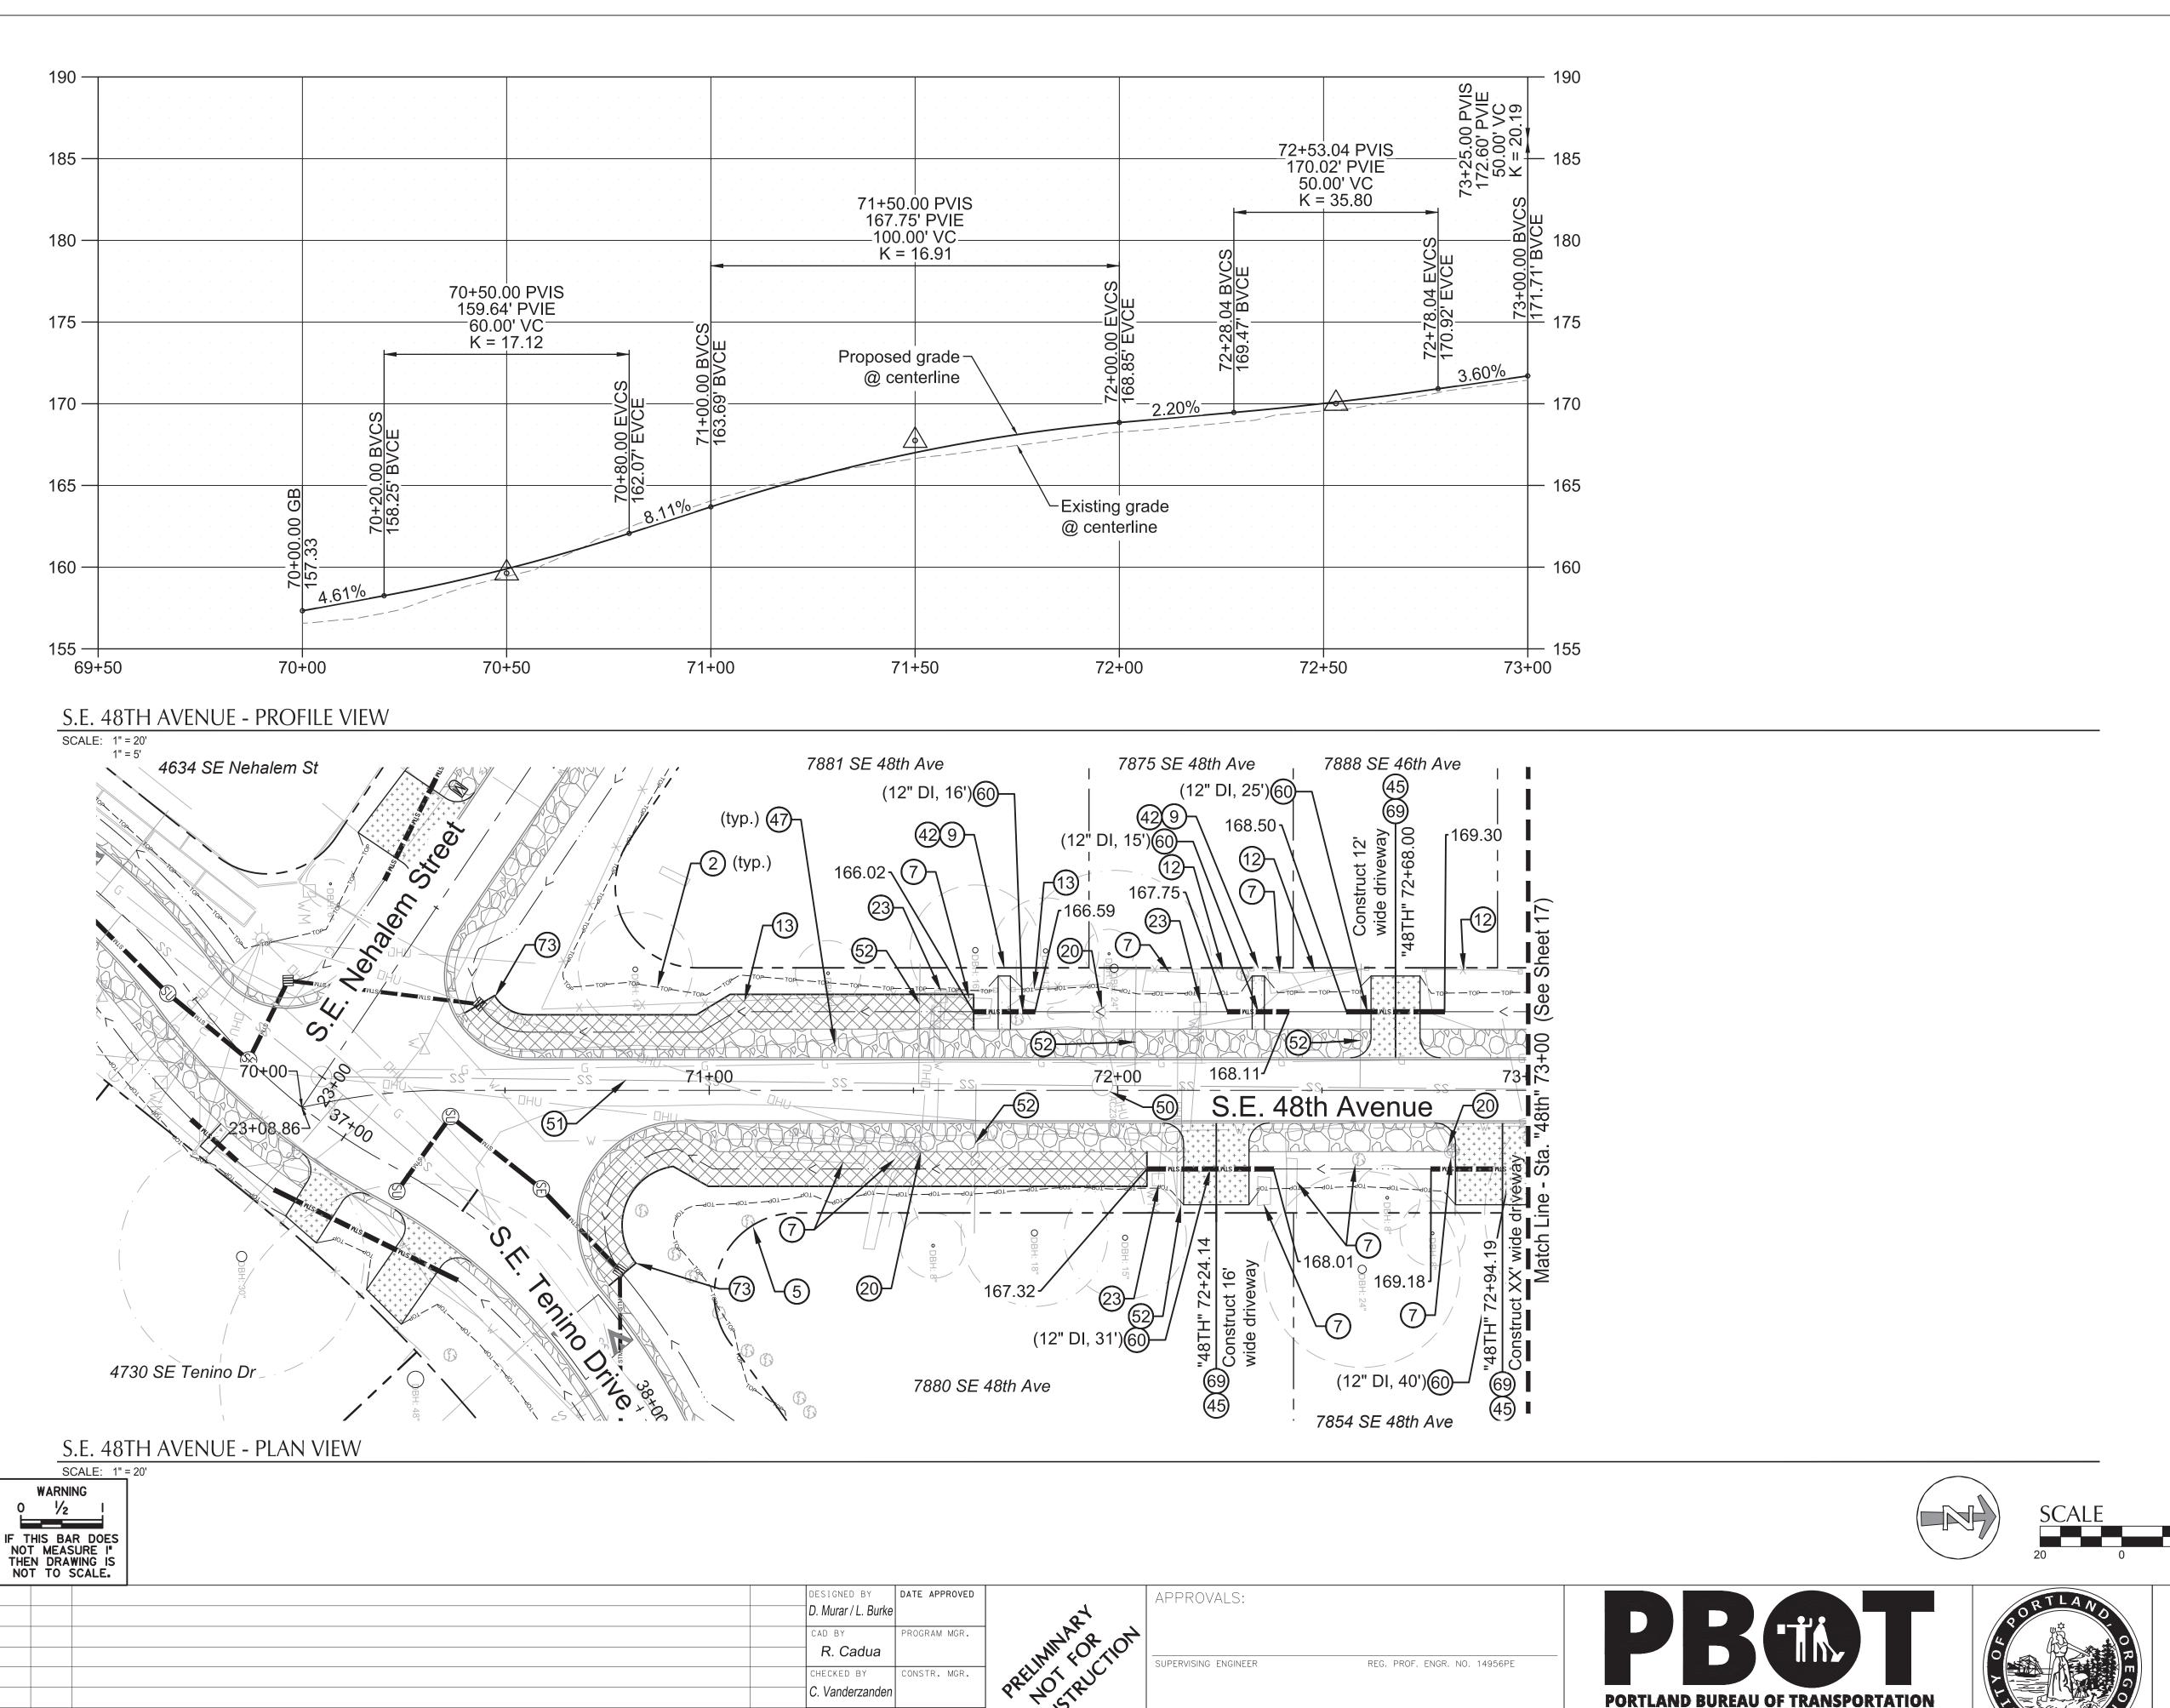

CITY ENGINEER

REG. PROF. ENGR. NO. 51538PE

CHLOE EUDALY

STEVE TOWNSEN, P.E.

COMMISSIONER

CITY ENGINEER

NO. DATE

DESCRIPTION

REVISION

APPD.


90% DESIGN REVIEW OCTOBER 4, 2019

### **General Notes:**

- 1 See Shts. 2H-1 thru 2H-13 for Tree Protection Plans
- 2 See Shts. D-1 thru D-15 for Drainage Plans.
- 3 See Shts. S-1 thru S-4 for Signing and Striping Plans.
- 4 See Shts. L-1 thru L-15 for Landscape Plans.

### O Construction Notes

- 2 Limits of cut/fill.
- 5 Protect brush, hedge, other vegetation, or landscaping.
- 7 Remove brush, hedge, other vegetation, or landscaping.
- 9 Remove sidewalk.
- 12 Protect fence.
- 13 Remove fence and salvage to owner.
- 20 Relocate utility pole / guy wire (by others). Coodinate with utility company.
- 23 Water meter to be relocated by PWB.
- 42 Construct concrete sidewalk. See Std. Drg. No. P-551.
- 45 Construct asphalt driveway connection. See Std. Drg. No.
- 47 Construct aggregate shoulder 6 in. thick.
- 50 Adjust manhole to finished grade.
- 51 Protect sanitary sewer main.
- 52 Protect sanitary service lateral.
- 60 Install culvert. Length and size as shown.
- 69 Construct asphalt driveway. See sht. 2B-2 detail A.
- 73 Construct ditch amoring. See sht. 2B-2 detail D.

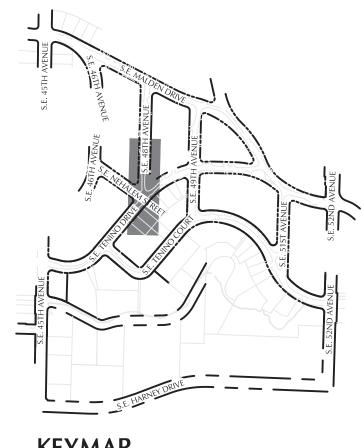




Portland, OR 97204 O: 503.227.3251 F: 503.224.4681 www.kpff.com Errol Heights
Street and Storm Improvements

1s2e19 T00526.D42 SHEET NO.

S.E. 48th Avenue Street Plan and Profile

16

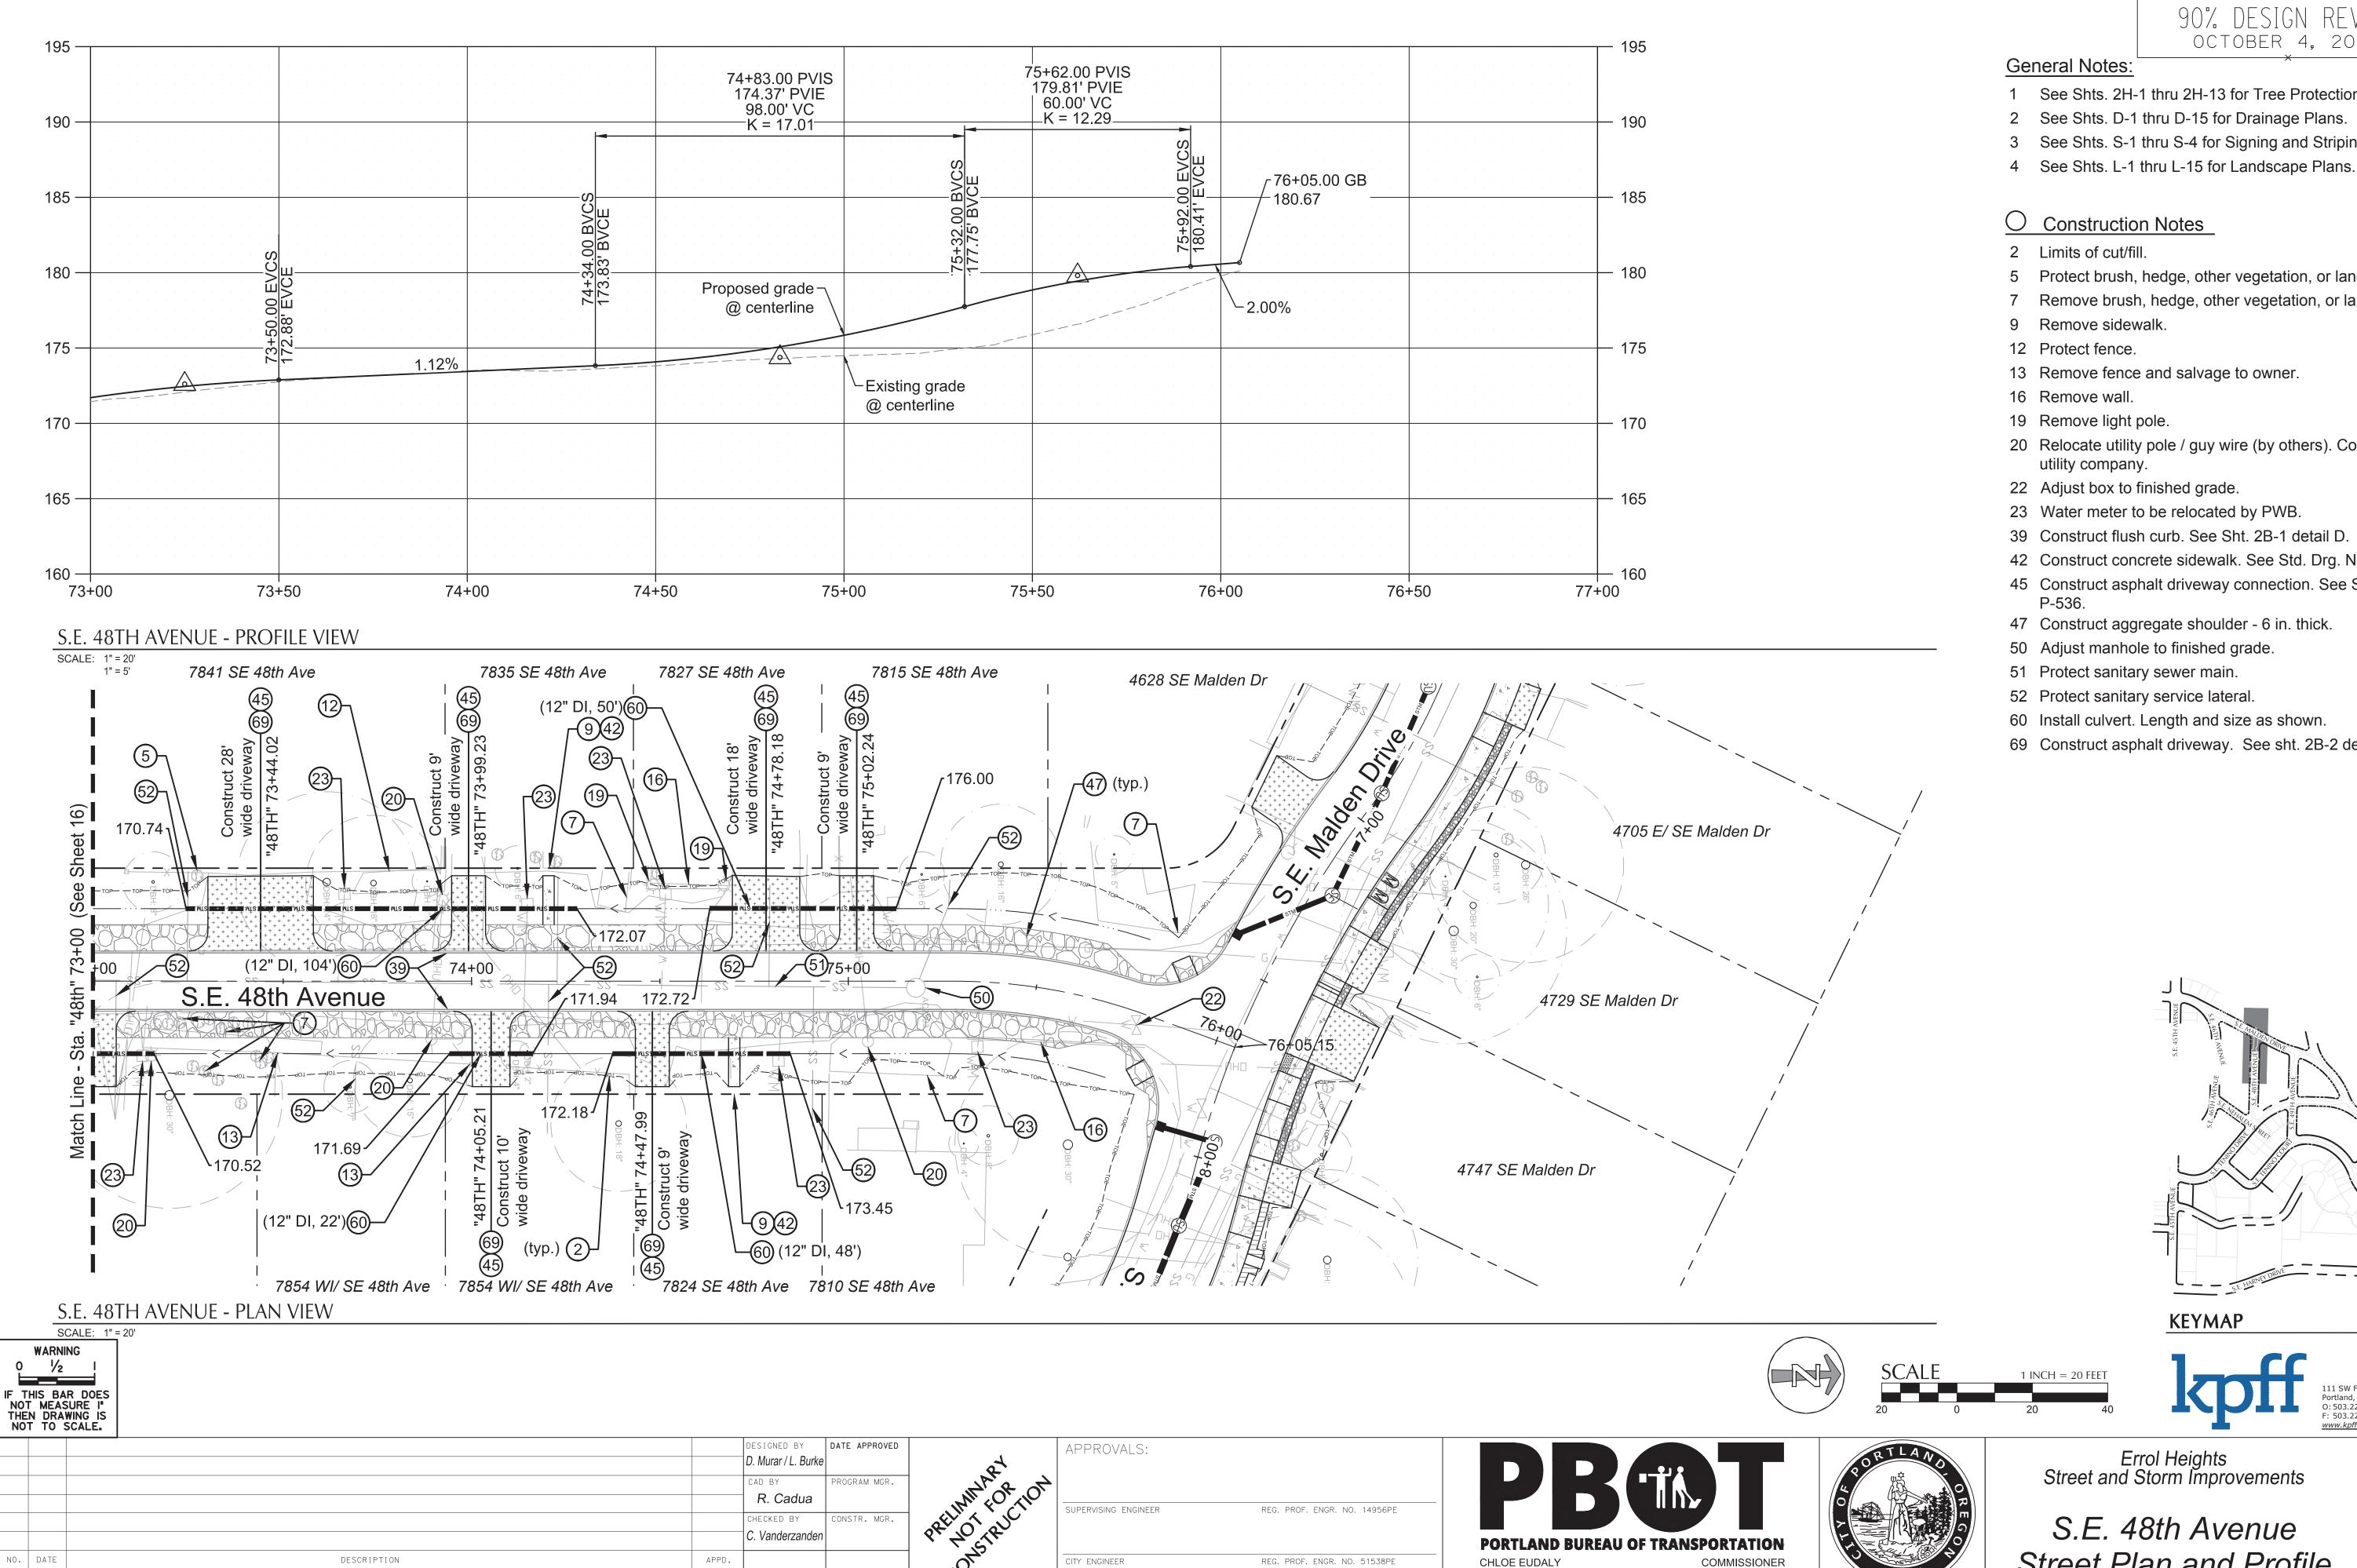


REVISION

90% DESIGN REVIEW OCTOBER 4, 2019

- 1 See Shts. 2H-1 thru 2H-13 for Tree Protection Plans
- 3 See Shts. S-1 thru S-4 for Signing and Striping Plans.
- 5 Protect brush, hedge, other vegetation, or landscaping.
- 7 Remove brush, hedge, other vegetation, or landscaping.
- 20 Relocate utility pole / guy wire (by others). Coodinate with

- 42 Construct concrete sidewalk. See Std. Drg. No. P-551.
- 45 Construct asphalt driveway connection. See Std. Drg. No.

- 69 Construct asphalt driveway. See sht. 2B-2 detail A.

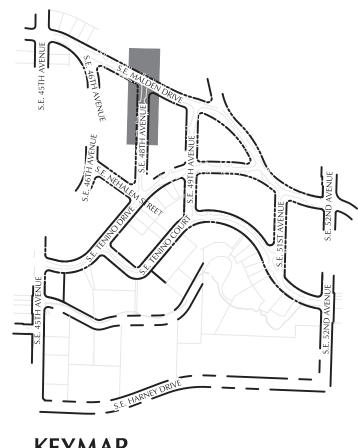




1s2e19 T00526.D42

Street Plan and Profile

CITY ENGINEER

STEVE TOWNSEN, P.E.

SHEET NO.

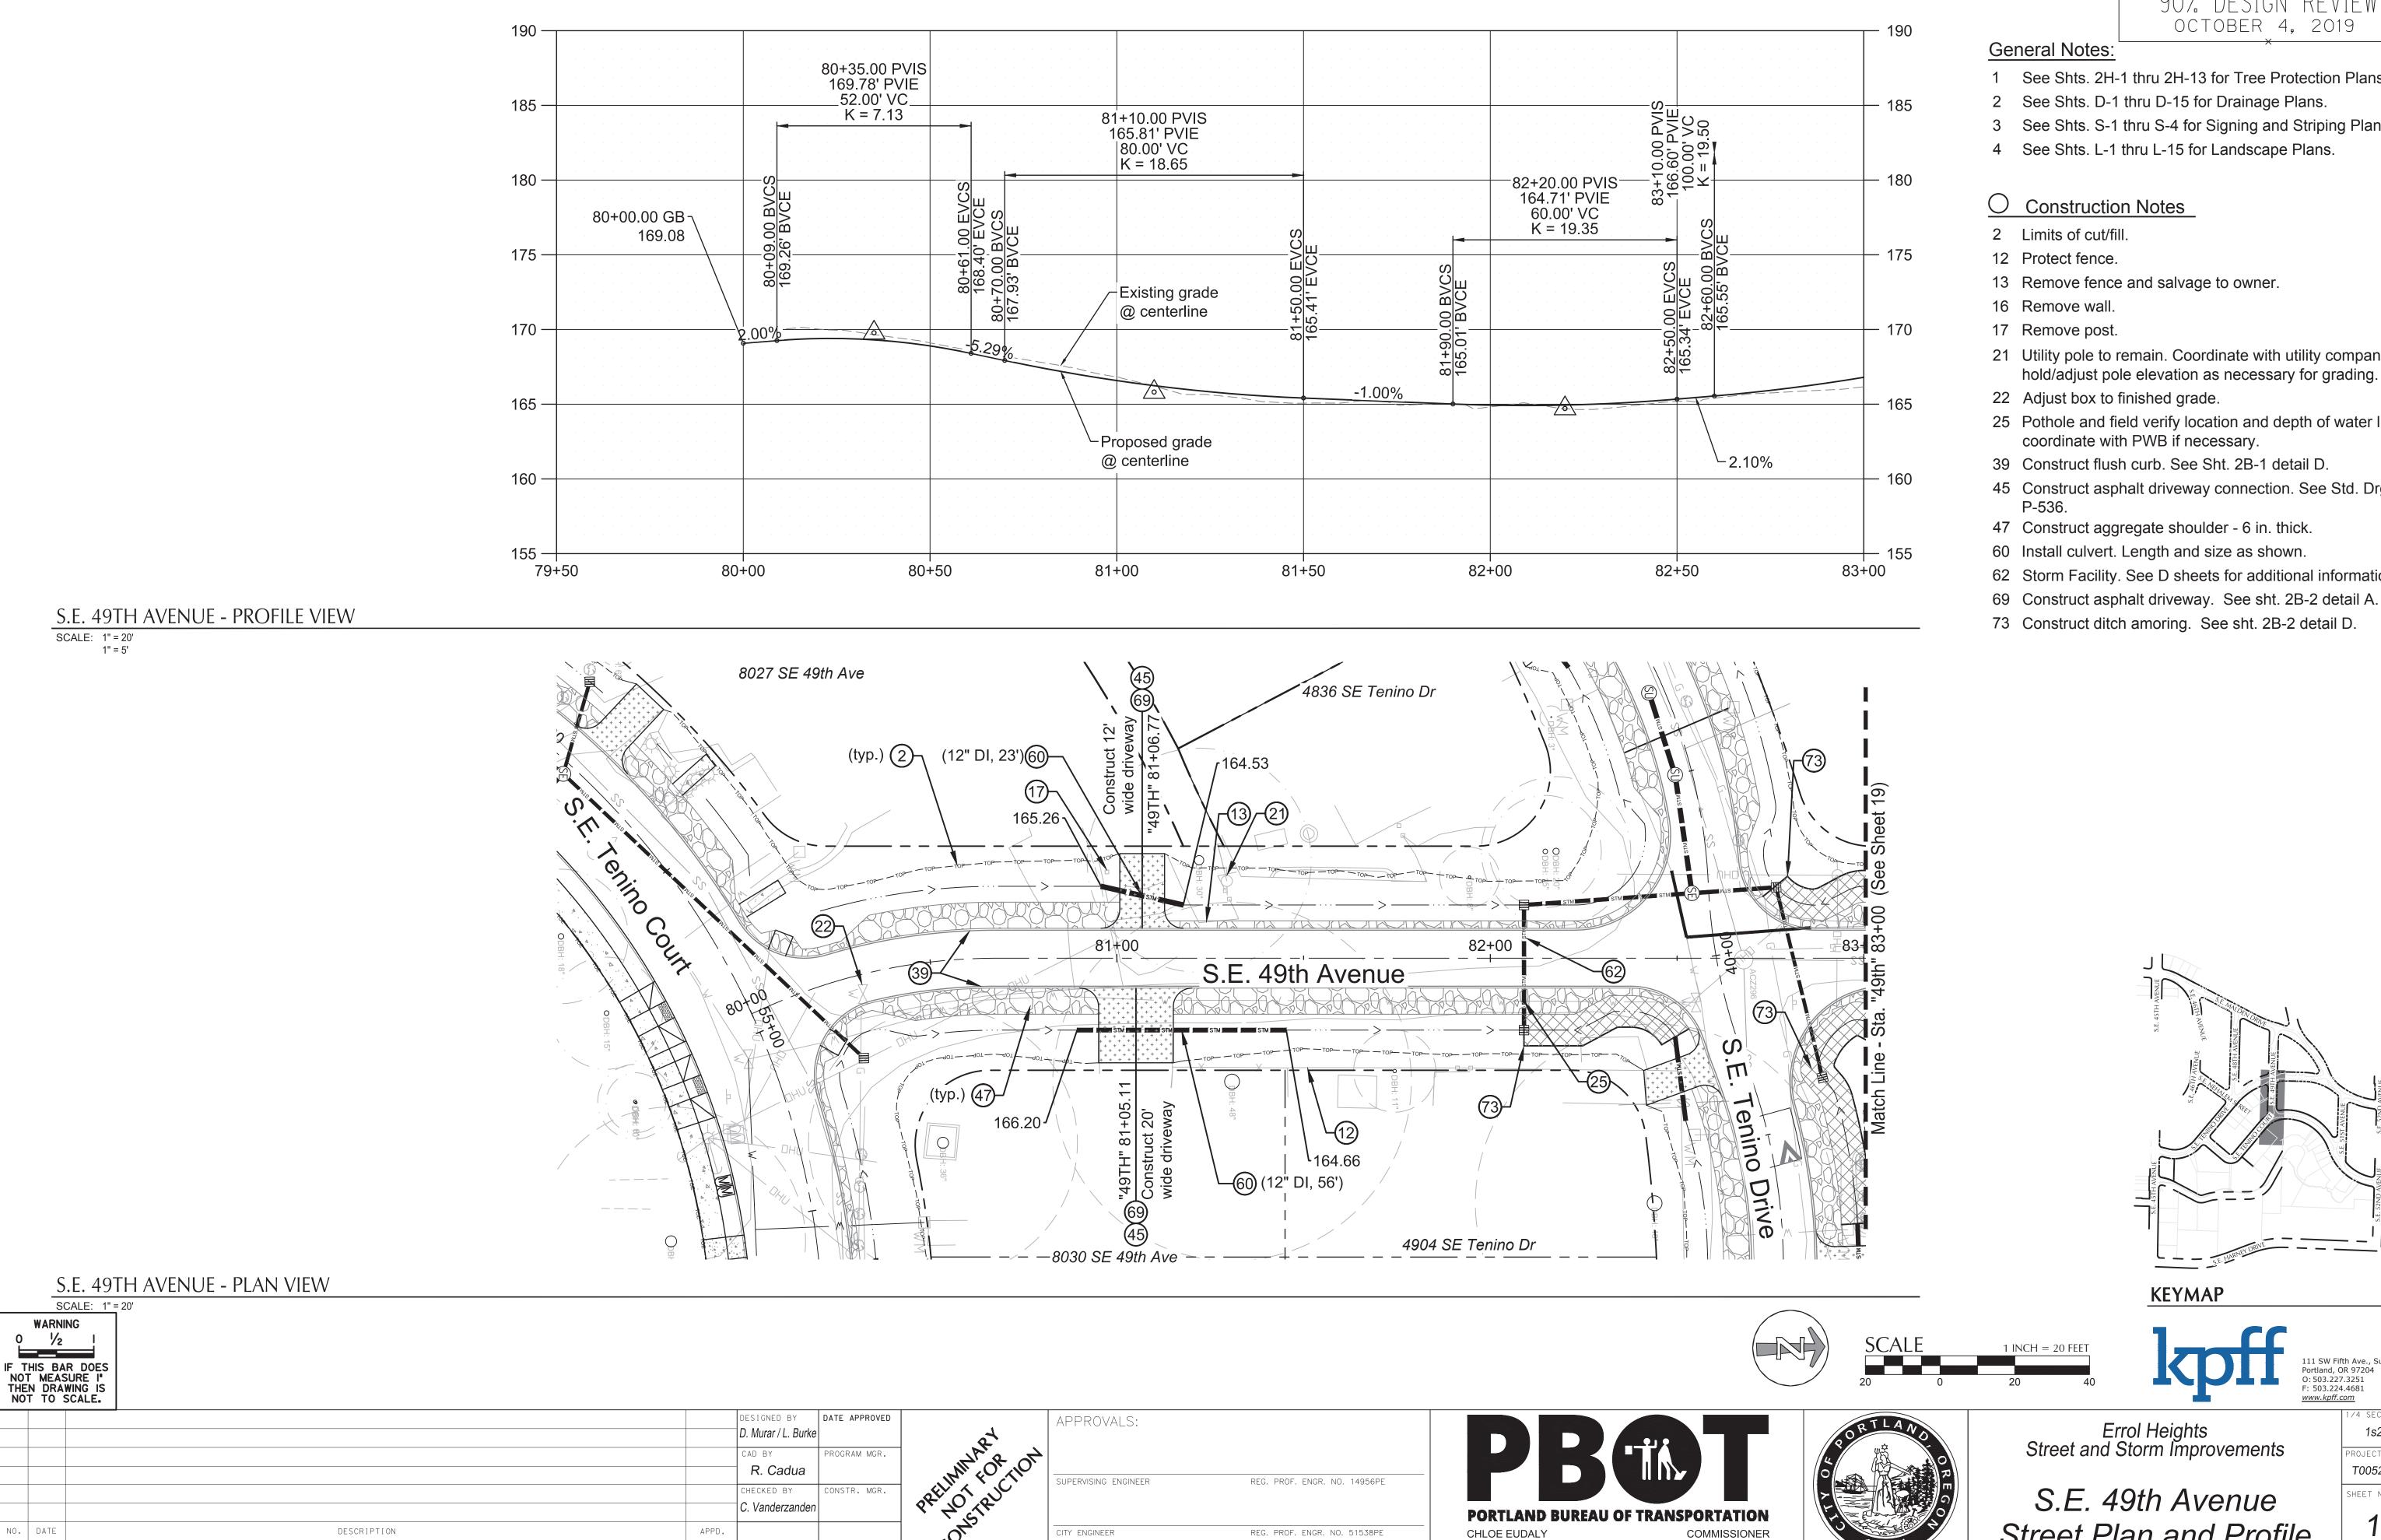


REVISION

90% DESIGN REVIEW OCTOBER 4, 2019

- 1 See Shts. 2H-1 thru 2H-13 for Tree Protection Plans
- 3 See Shts. S-1 thru S-4 for Signing and Striping Plans.

- 21 Utility pole to remain. Coordinate with utility company to hold/adjust pole elevation as necessary for grading.
- 25 Pothole and field verify location and depth of water line,
- 45 Construct asphalt driveway connection. See Std. Drg. No.

- 62 Storm Facility. See D sheets for additional information.

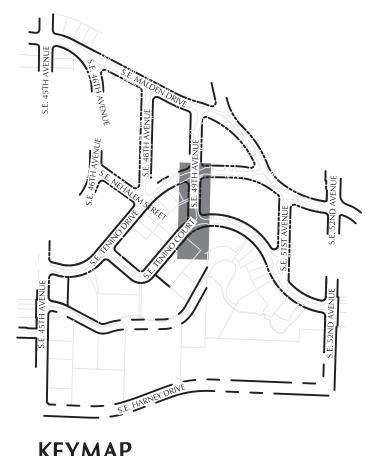



111 SW Fifth Ave., Suite 2500 Portland, OR 97204 O: 503.227.3251 F: 503.224.4681 www.kpff.com

Errol Heights
Street and Storm Improvements


CITY ENGINEER

STEVE TOWNSEN, P.E.

1s2e19 T00526.D42 SHEET NO.

Street Plan and Profile


18

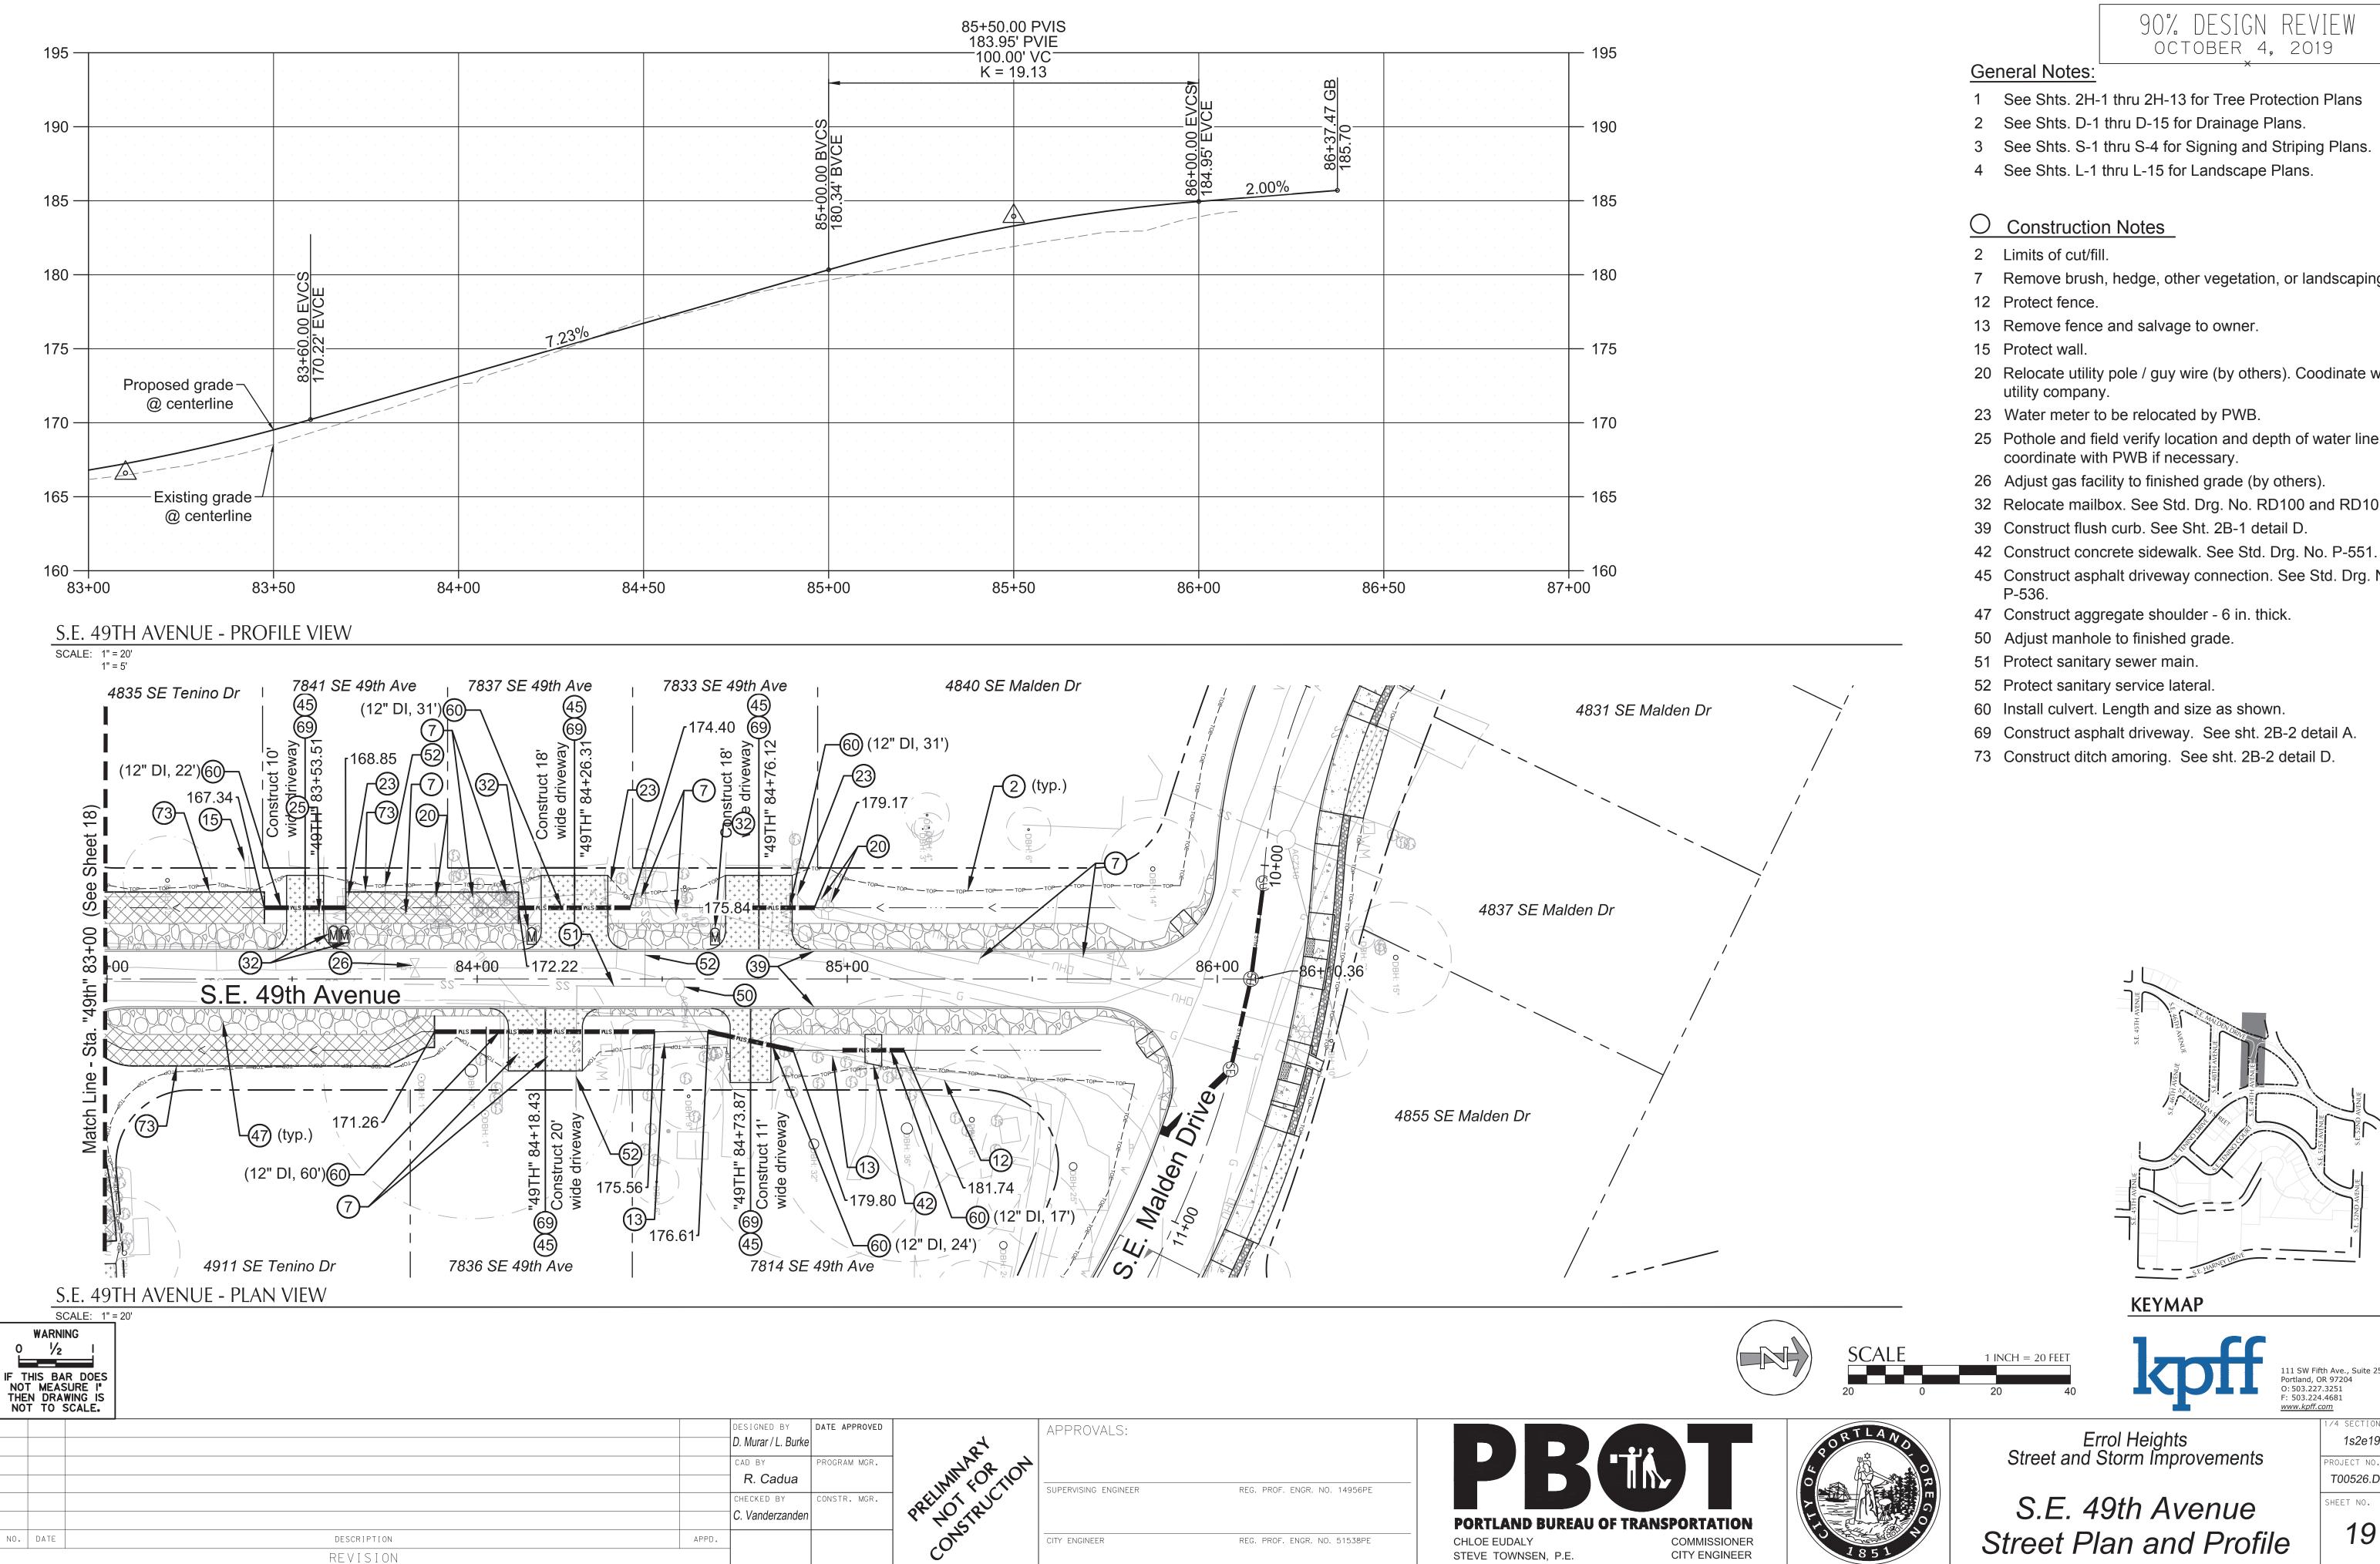

90% DESIGN REVIEW OCTOBER 4, 2019


- 1 See Shts. 2H-1 thru 2H-13 for Tree Protection Plans

- 7 Remove brush, hedge, other vegetation, or landscaping.
- 20 Relocate utility pole / guy wire (by others). Coodinate with
- 25 Pothole and field verify location and depth of water line,
- 32 Relocate mailbox. See Std. Drg. No. RD100 and RD101.
- 45 Construct asphalt driveway connection. See Std. Drg. No.

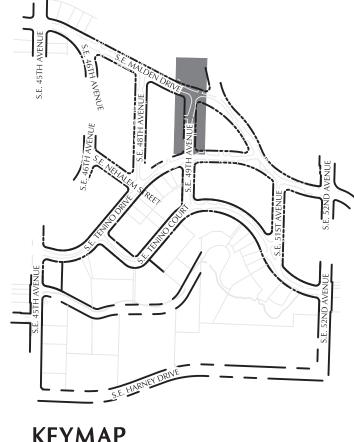

Portland, OR 97204 O: 503.227.3251 F: 503.224.4681 www.kpff.com

1s2e19 T00526.D42 SHEET NO.

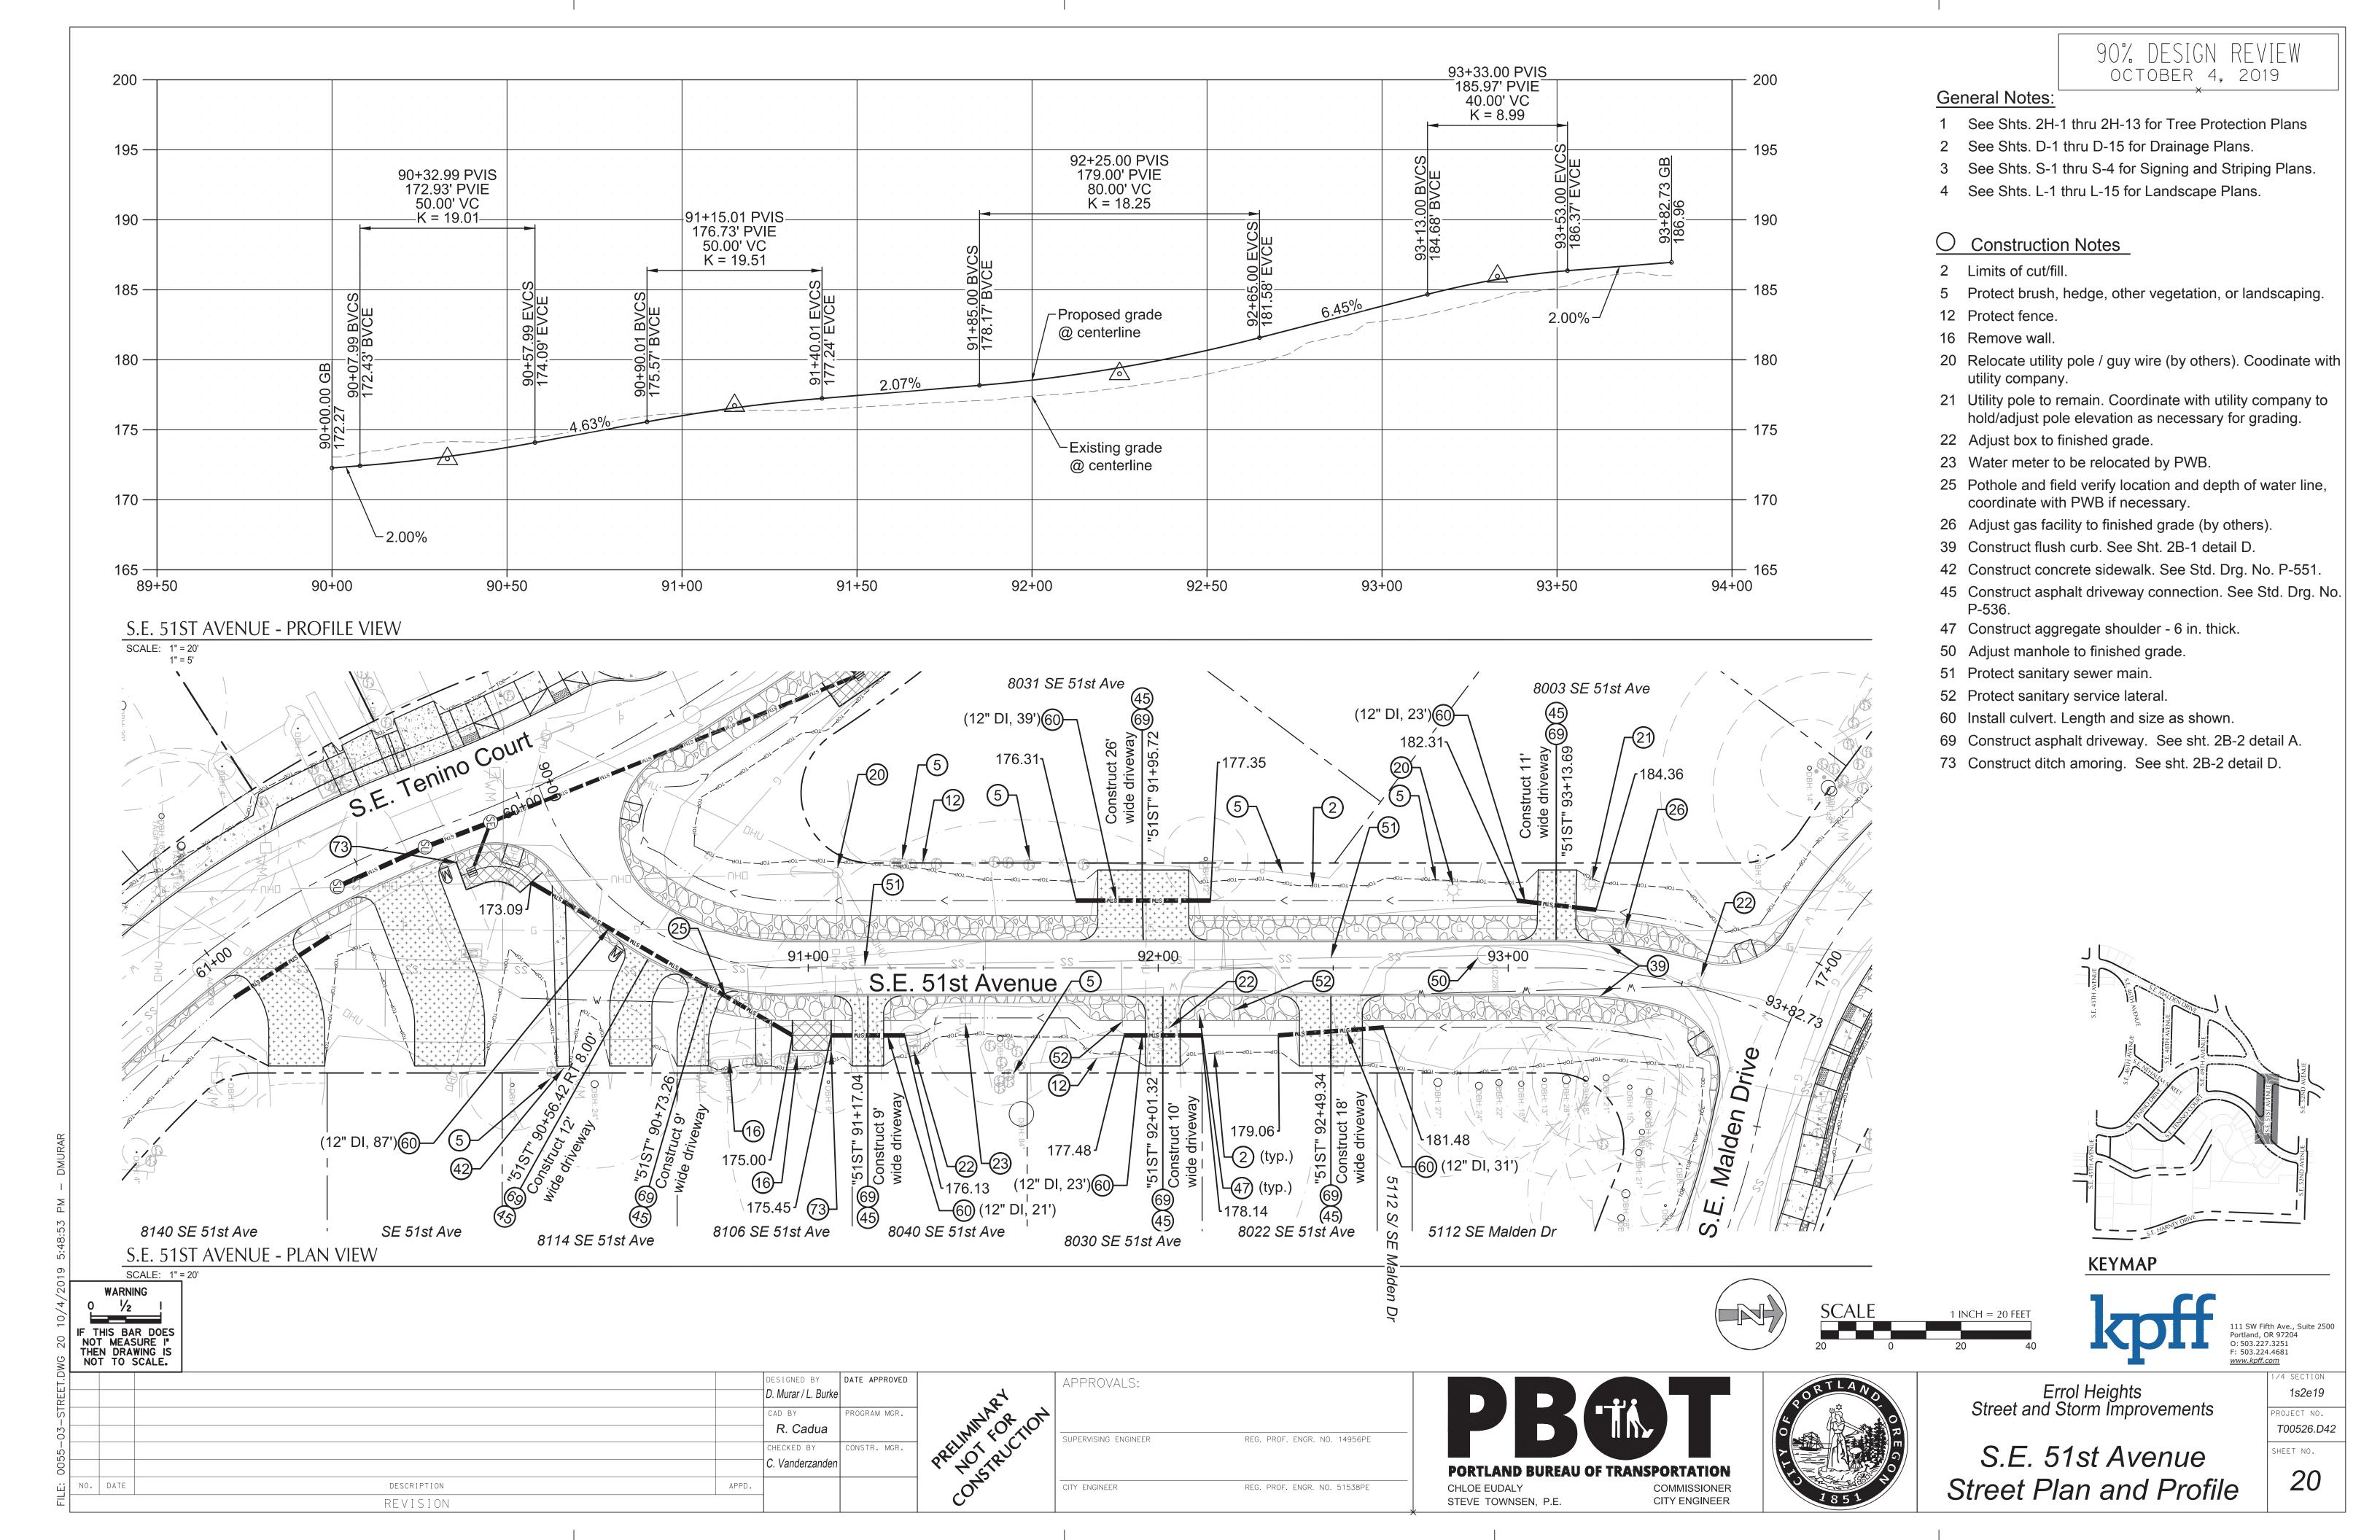


## 90% DESIGN REVIEW OCTOBER 4, 2019


### General Notes:

- 1 See Shts. 2H-1 thru 2H-13 for Tree Protection Plans
- 2 See Shts. D-1 thru D-15 for Drainage Plans.
- 3 See Shts. S-1 thru S-4 for Signing and Striping Plans.
- 4 See Shts. L-1 thru L-15 for Landscape Plans.

# O Construction Notes

- 2 Limits of cut/fill.
- 20 Relocate utility pole / guy wire (by others). Coodinate with utility company.
- 40 Construct standard curb. See Std. Drg. No. P-540.
- 42 Construct concrete sidewalk. See Std. Drg. No. P-551.
- 43 Construct curb ramp. See Std. Drg. No. P-547 & p-548.
- 48 Construct gabion cut retaining wall. See Sht. 2B-1 detail

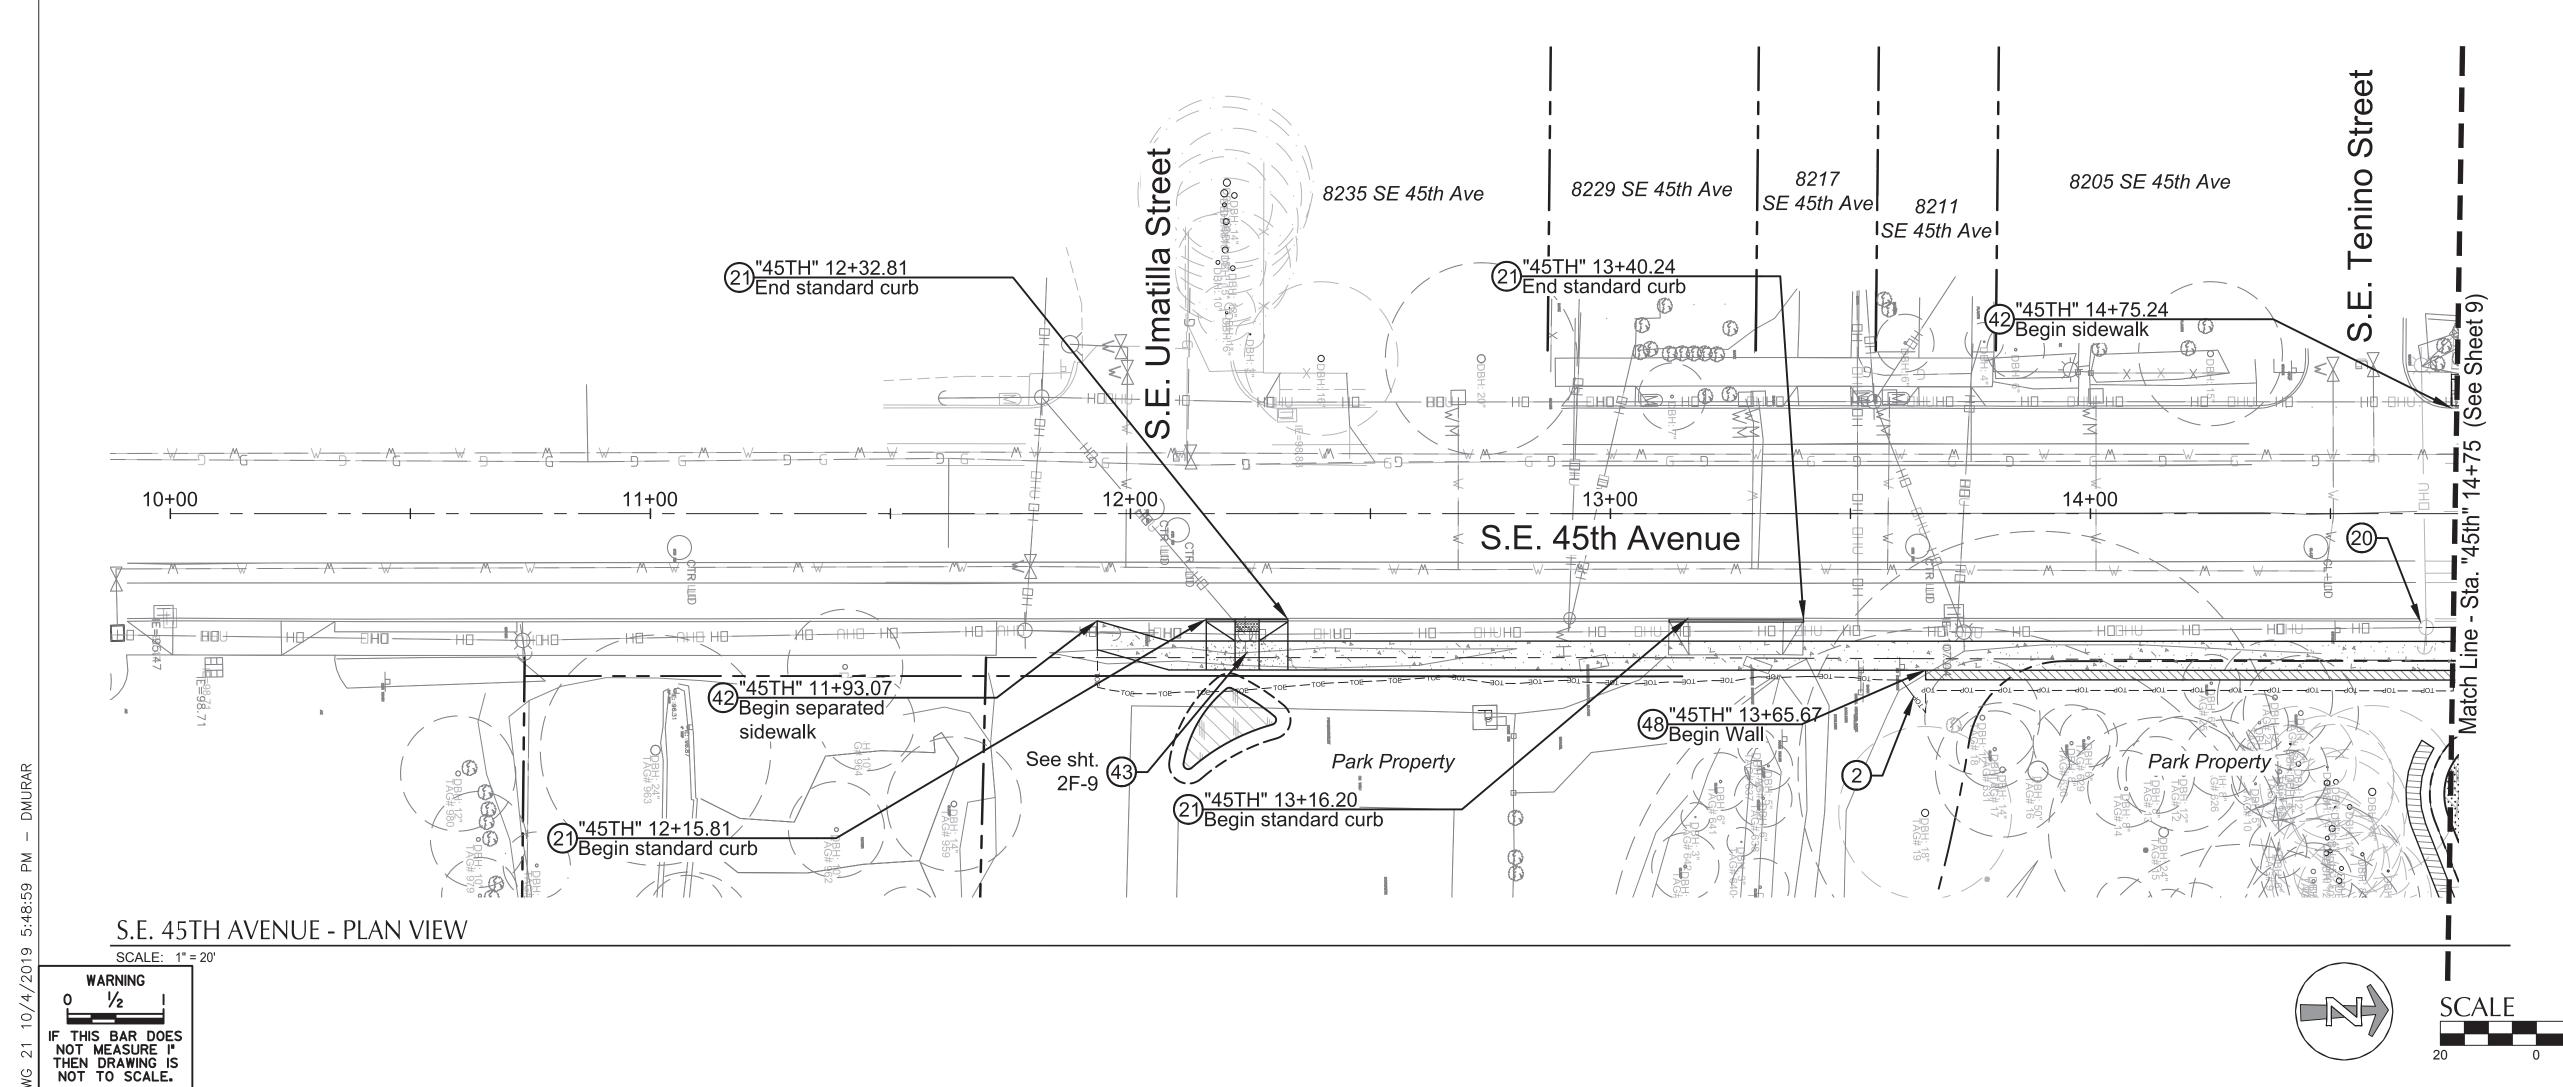

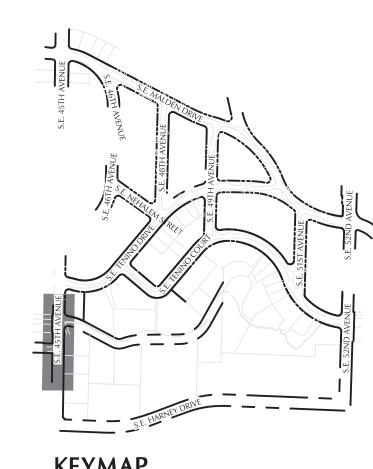

**KEYMAP** 



111 SW Fifth Ave., Suite 2500 Portland, OR 97204 O: 503.227.3251 F: 503.224.4681 www.kpff.com

1s2e19

PROJECT NO.

CHLOE EUDALY

STEVE TOWNSEN, P.E.



Errol Heights
Street and Storm Improvements

T00526.D42 SHEET NO.

S.E. 45th Avenue Street Plan and Profile

NO. DATE

DESCRIPTION

REVISION

CONSTR. MGR.

APPROVALS:

DATE APPROVED

ROGRAM MGR.

DESIGNED BY

CAD BY

APPD.

D. Murar / L. Burke

R. Cadua

CHECKED BY

C. Vanderzander

SUPERVISING ENGINEER REG. PROF. ENGR. NO. 14956PE CITY ENGINEER REG. PROF. ENGR. NO. 51538PE

COMMISSIONER CITY ENGINEER


# 90% DESIGN REVIEW OCTOBER 4, 2019


### General Notes:

- 1 See Shts. 2H-1 thru 2H-13 for Tree Protection Plans
- 2 See Shts. D-1 thru D-15 for Drainage Plans.
- 3 See Shts. S-1 thru S-4 for Signing and Striping Plans.
- 4 See Shts. L-1 thru L-15 for Landscape Plans.

# O Construction Notes

- 2 Limits of cut/fill.
- 20 Relocate utility pole / guy wire (by others). Coodinate with utility company.
- 40 Construct standard curb. See Std. Drg. No. P-540.
- 42 Construct concrete sidewalk. See Std. Drg. No. P-551.
- 44 Construct concrete driveway connection. See Std. Drg. No. P-536.
- 46 Construct modular retaining wall. See Sht. 2B-1 detail A.
- 70 Construct partially lowered concrete driveway. See Std. Drg. No. P-532.

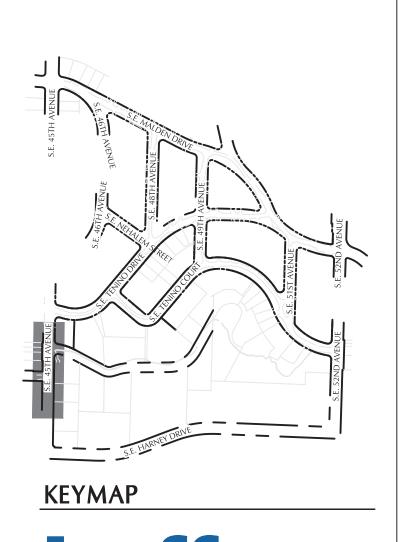

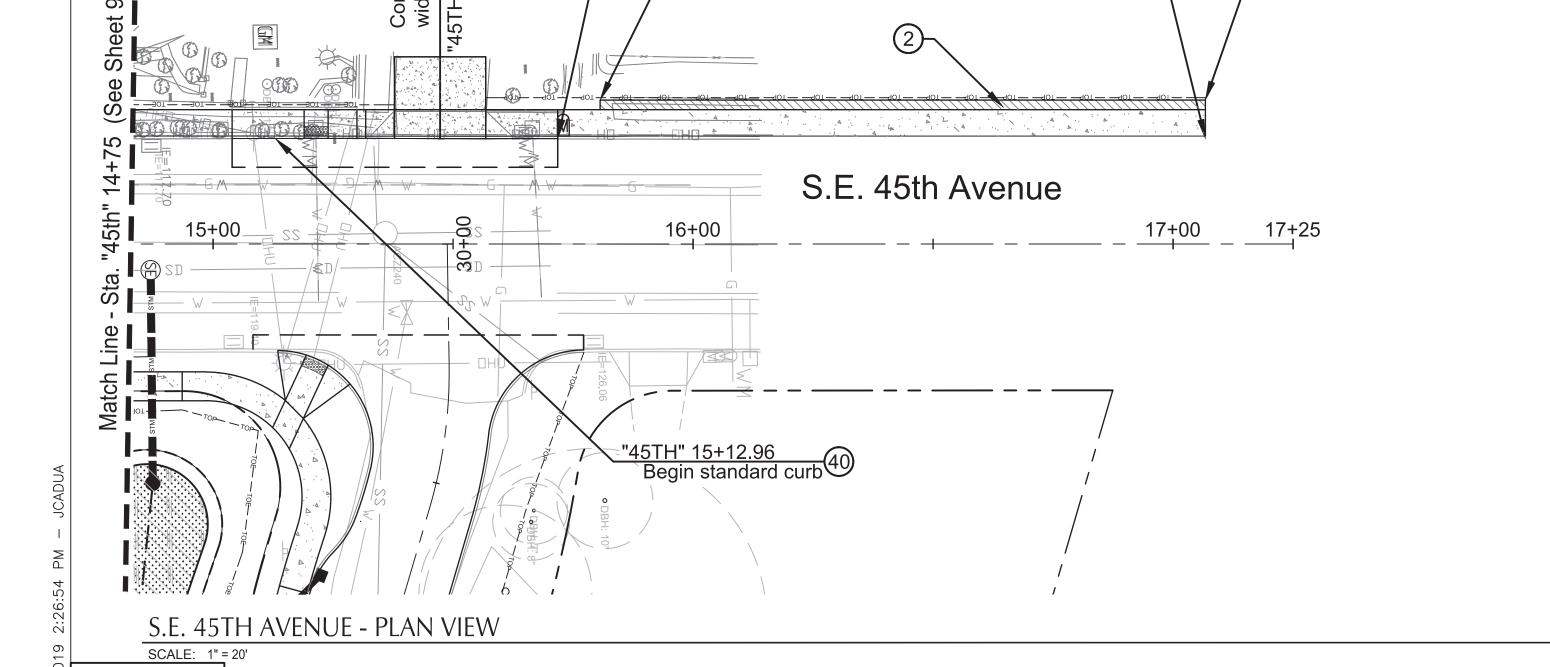

"45TH" 15+71.80 End standard curb

"45TH" 15+80.62 Begin Wall

42"45TH" 17+06.74 End sidewalk

DESIGNED BY

D. Murar / L. Burke

R. Cadua

C. Vanderzanden

CHECKED BY

APPD.

PORTLAND BUREAU OF TRANSPORTATION COMMISSIONER CHLOE EUDALY





Errol Heights
Street and Storm Improvements

T00526.D42 SHEET NO.

111 SW Fifth Ave., Suite 2500 Portland, OR 97204 O: 503.227.3251 F: 503.224.4681 www.kpff.com

1s2e19

S.E. 45th Avenue Street Plan and Profile

DESCRIPTION

REVISION

IF THIS BAR DOES NOT MEASURE I' THEN DRAWING IS NOT TO SCALE.

NO. DATE

CITY ENGINEER REG. PROF. ENGR. NO. 51538PE STEVE TOWNSEN, P.E.

REG. PROF. ENGR. NO. 14956PE

APPROVALS:

SUPERVISING ENGINEER

"45TH" 17+06.74 End Wall


CITY ENGINEER

### General Notes:

- 1 See Shts. 2H-1 thru 2H-13 for Tree Protection Plans
- 2 See Shts. D-1 thru D-15 for Drainage Plans.
- 3 See Shts. S-1 thru S-4 for Signing and Striping Plans.
- 4 See Shts. L-1 thru L-15 for Landscape Plans.

# O Construction Notes

- 2 Limits of cut/fill.
- 20 Relocate utility pole / guy wire (by others). Coodinate with utility company.
- 23 Water meter to be relocated by PWB.
- 31 Relocate sign and post. See Shts S-1 thru S-4.
- 32 Relocate mailbox. See Std. Drg. No. RD100 and RD101.
- 35 Remove driveway.
- 38 Construct gabion fill retaining wall. See Sht. 2B-1 detail
- 40 Construct standard curb. See Std. Drg. No. P-540.
- 42 Construct concrete sidewalk. See Std. Drg. No. P-551.
- 50 Adjust manhole to finished grade.

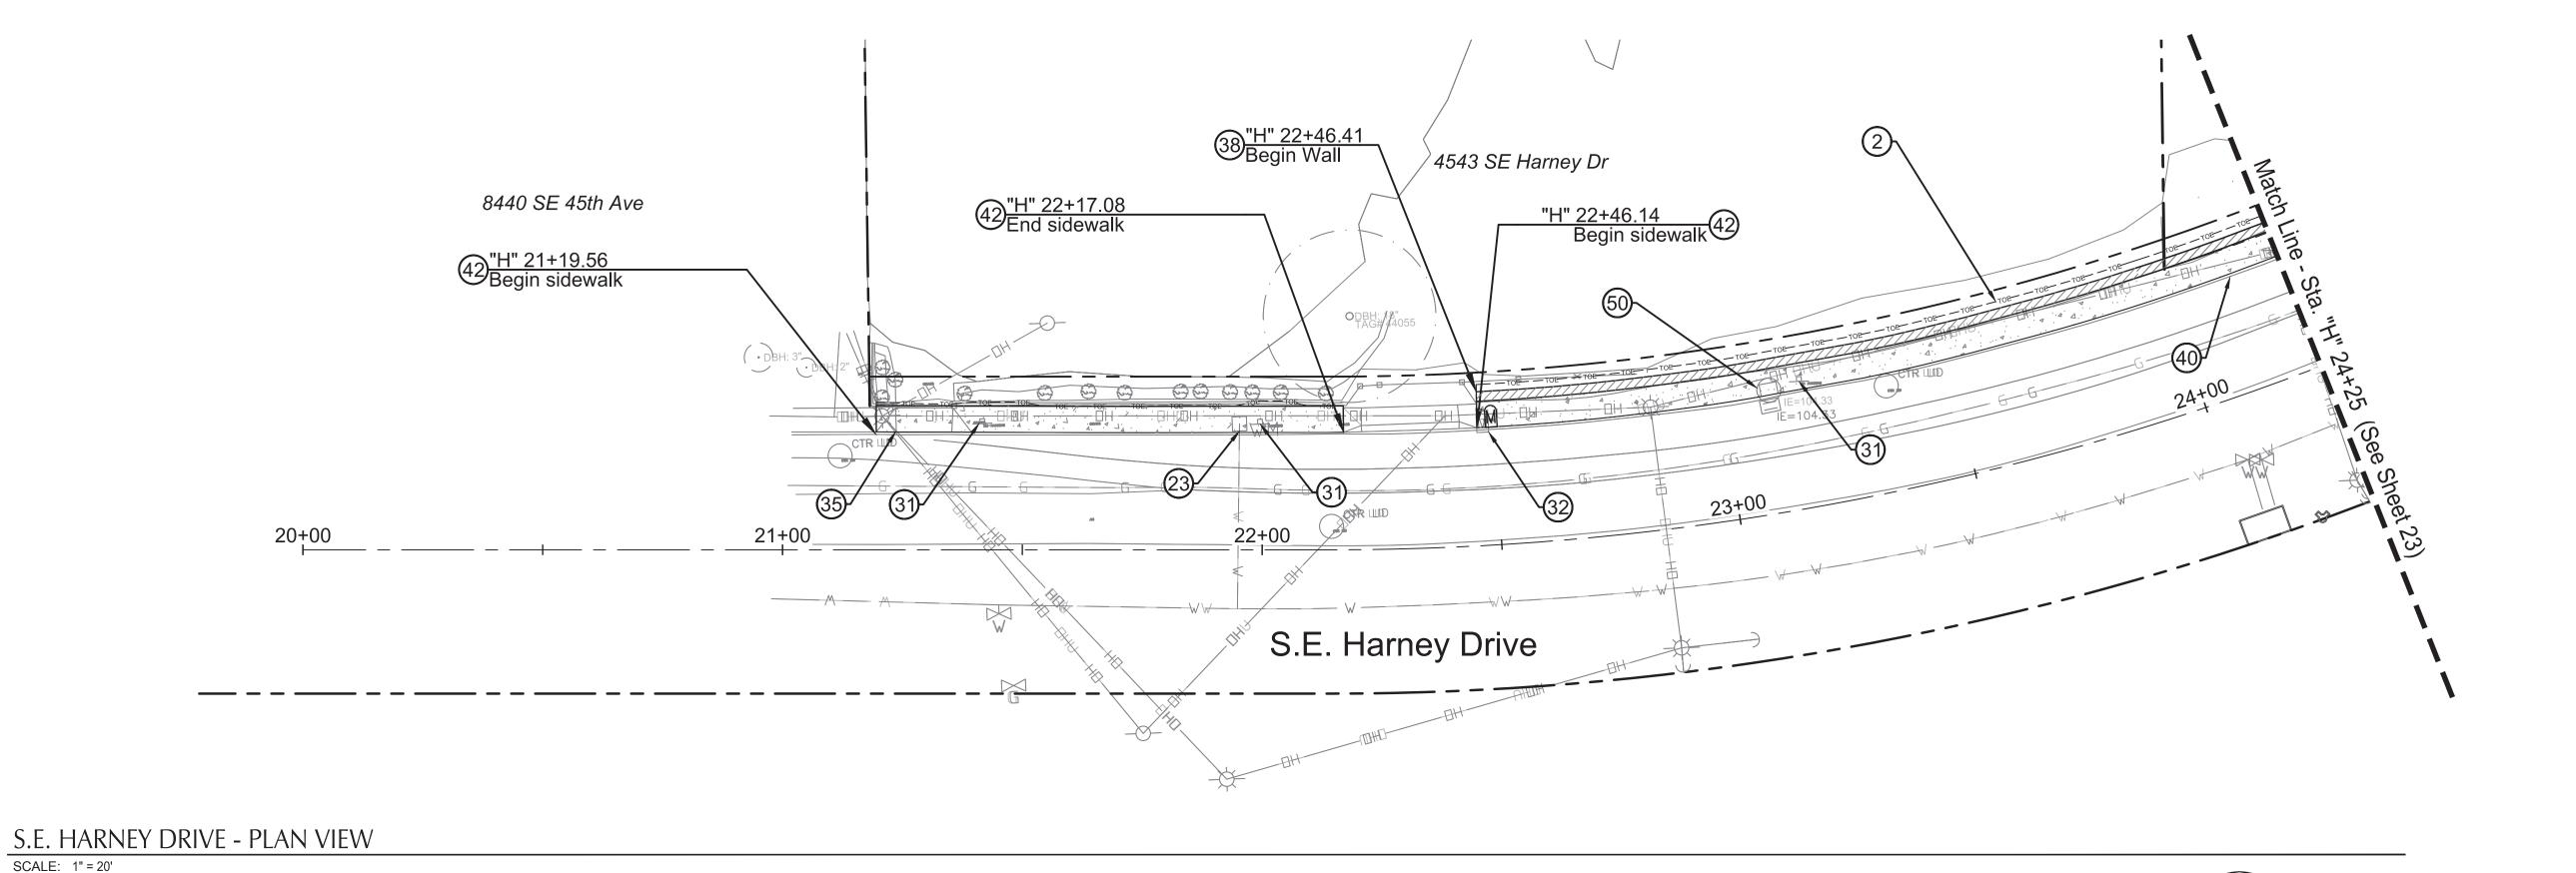


**KEYMAP** 



111 SW Fifth Ave., Suite 2500 Portland, OR 97204 O: 503.227.3251 F: 503.224.4681 www.kpff.com

IF THIS BAR DOES NOT MEASURE I' THEN DRAWING IS NOT TO SCALE. DATE APPROVED DESIGNED BY D. Murar / L. Burke CAD BY R. Cadua CHECKED BY C. Vanderzanden NO. DATE DESCRIPTION APPD. REVISION

APPROVALS: SUPERVISING ENGINEER REG. PROF. ENGR. NO. 14956PE CITY ENGINEER REG. PROF. ENGR. NO. 51538PE

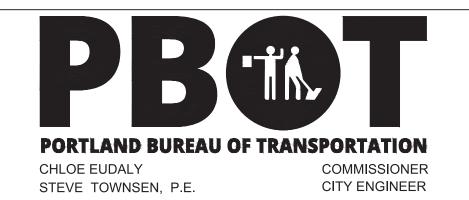



Errol Heights
Street and Storm Improvements

S.E. Harney Drive Street Plan and Profile


1s2e19 PROJECT NO. T00526.D42 SHEET NO.


### General Notes:

- 1 See Shts. 2H-1 thru 2H-13 for Tree Protection Plans
- 2 See Shts. D-1 thru D-15 for Drainage Plans.
- 3 See Shts. S-1 thru S-4 for Signing and Striping Plans.
- 4 See Shts. L-1 thru L-15 for Landscape Plans.

# O Construction Notes

- 2 Limits of cut/fill.
- 20 Relocate utility pole / guy wire (by others). Coodinate with utility company.
- 31 Relocate sign and post. See Shts S-1 thru S-4.
- 35 Remove driveway.
- 38 Construct gabion fill retaining wall. See Sht. 2B-1 detail
- 40 Construct standard curb. See Std. Drg. No. P-540.
- 42 Construct concrete sidewalk. See Std. Drg. No. P-551.
- 58 Remove water meter.

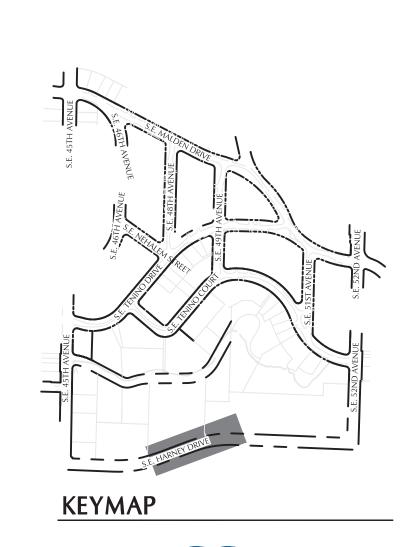

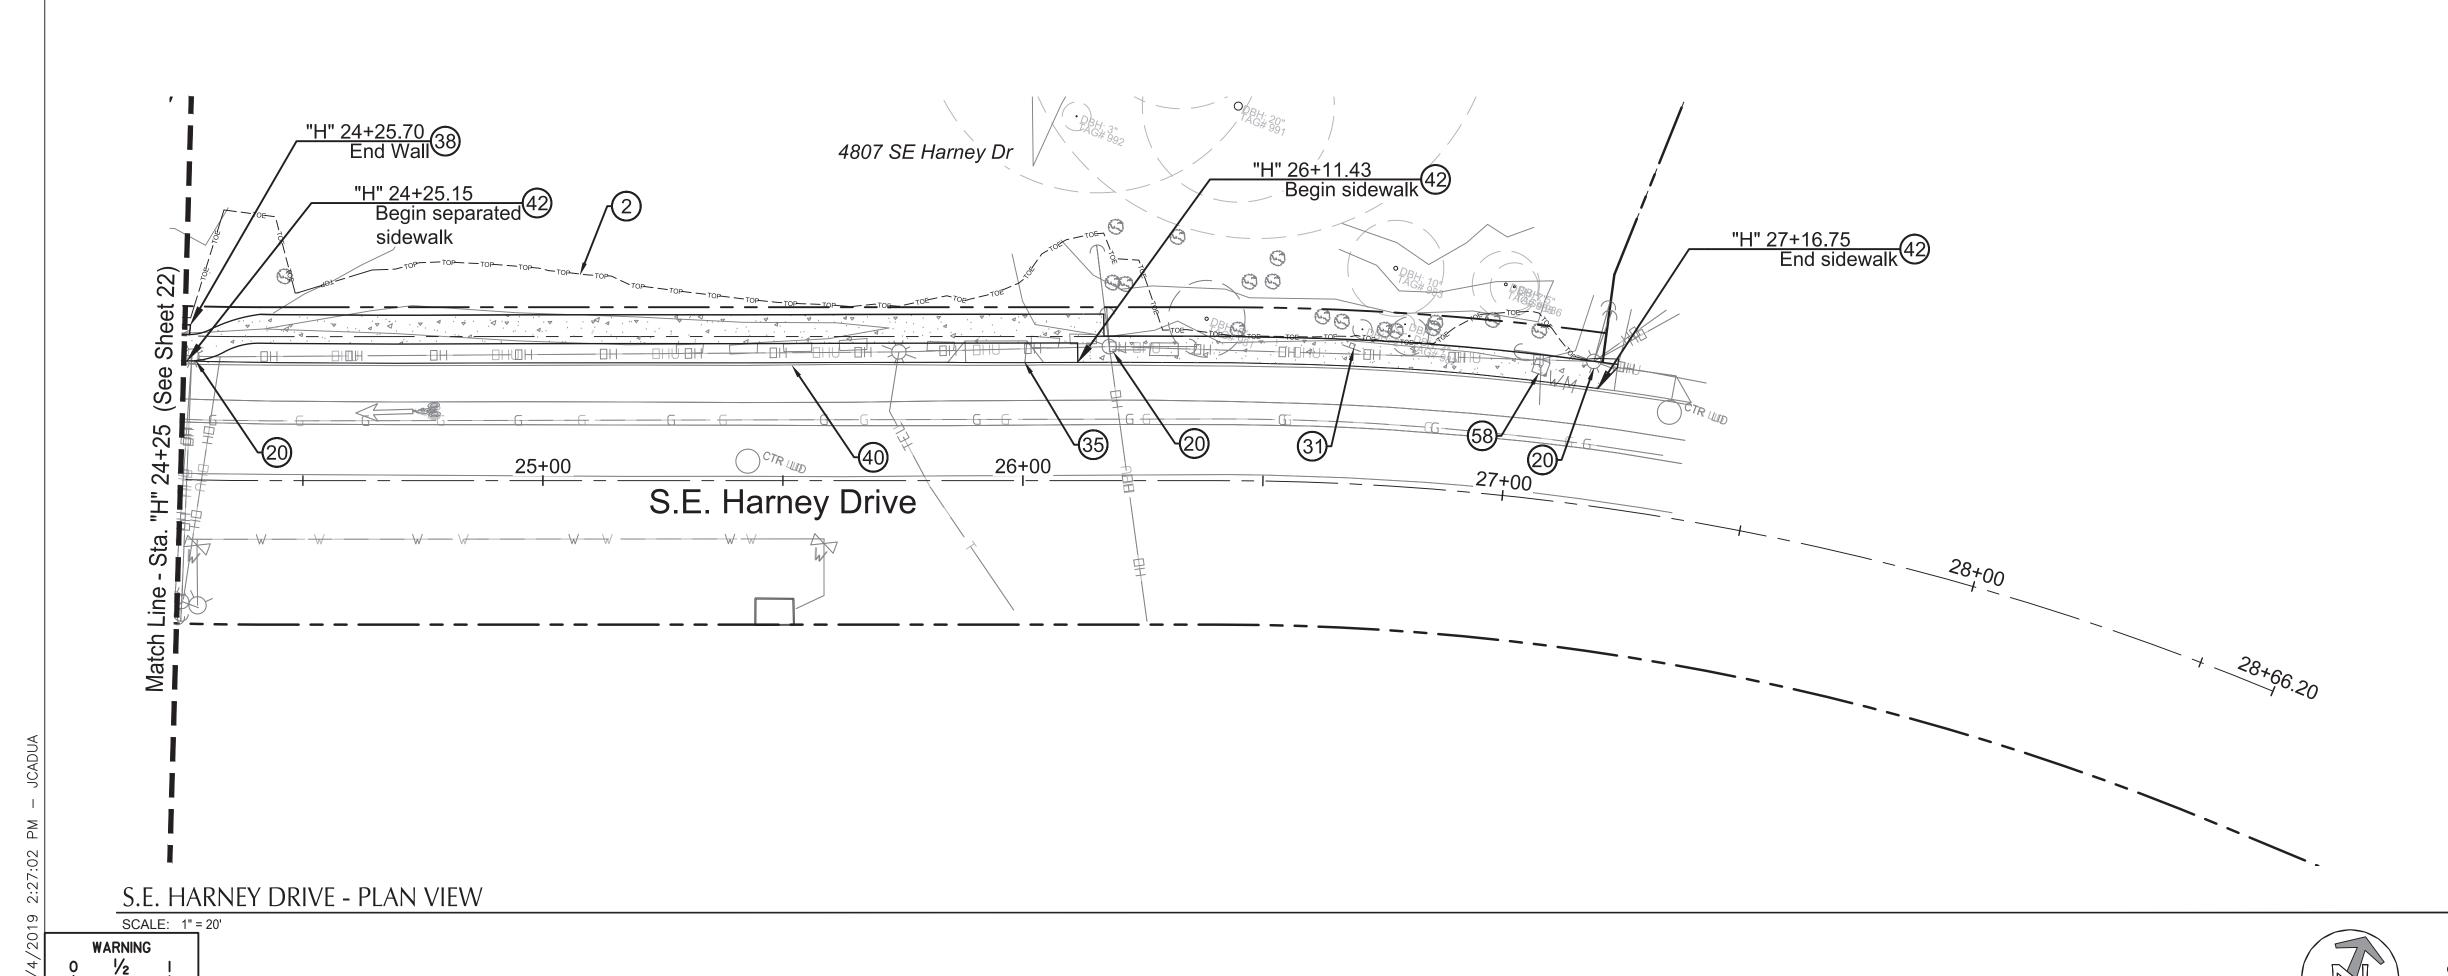

DATE APPROVED

ROGRAM MGR.

DESIGNED BY

CAD BY

D. Murar / L. Burke

R. Cadua

CHECKED BY

C. Vanderzanden





Errol Heights
Street and Storm Improvements

PROJECT NO. T00526.D42 SHEET NO. 24

111 SW Fifth Ave., Suite 2500 Portland, OR 97204 O: 503.227.3251 F: 503.224.4681 www.kpff.com

1s2e19

S.E. Harney Drive Street Plan and Profile

APPD.

DESCRIPTION

REVISION

IF THIS BAR DOES NOT MEASURE I' THEN DRAWING IS NOT TO SCALE.

NO. DATE

APPROVALS:

SUPERVISING ENGINEER REG. PROF. ENGR. NO. 14956PE CITY ENGINEER REG. PROF. ENGR. NO. 51538PE

**PORTLAND BUREAU OF TRANSPORTATION** CHLOE EUDALY STEVE TOWNSEN, P.E.


COMMISSIONER CITY ENGINEER


### General Notes:

- 1 See Shts. 2H-1 thru 2H-13 for Tree Protection Plans
- 2 See Shts. D-1 thru D-15 for Drainage Plans.
- 3 See Shts. S-1 thru S-4 for Signing and Striping Plans.
- 4 See Shts. L-1 thru L-15 for Landscape Plans.

# O Construction Notes

- 2 Limits of cut/fill.
- 20 Relocate utility pole / guy wire (by others). Coodinate with utility company.
- 42 Construct concrete sidewalk. See Std. Drg. No. P-551.
- 43 Construct curb ramp. See Std. Drg. No. P-547 & p-548.

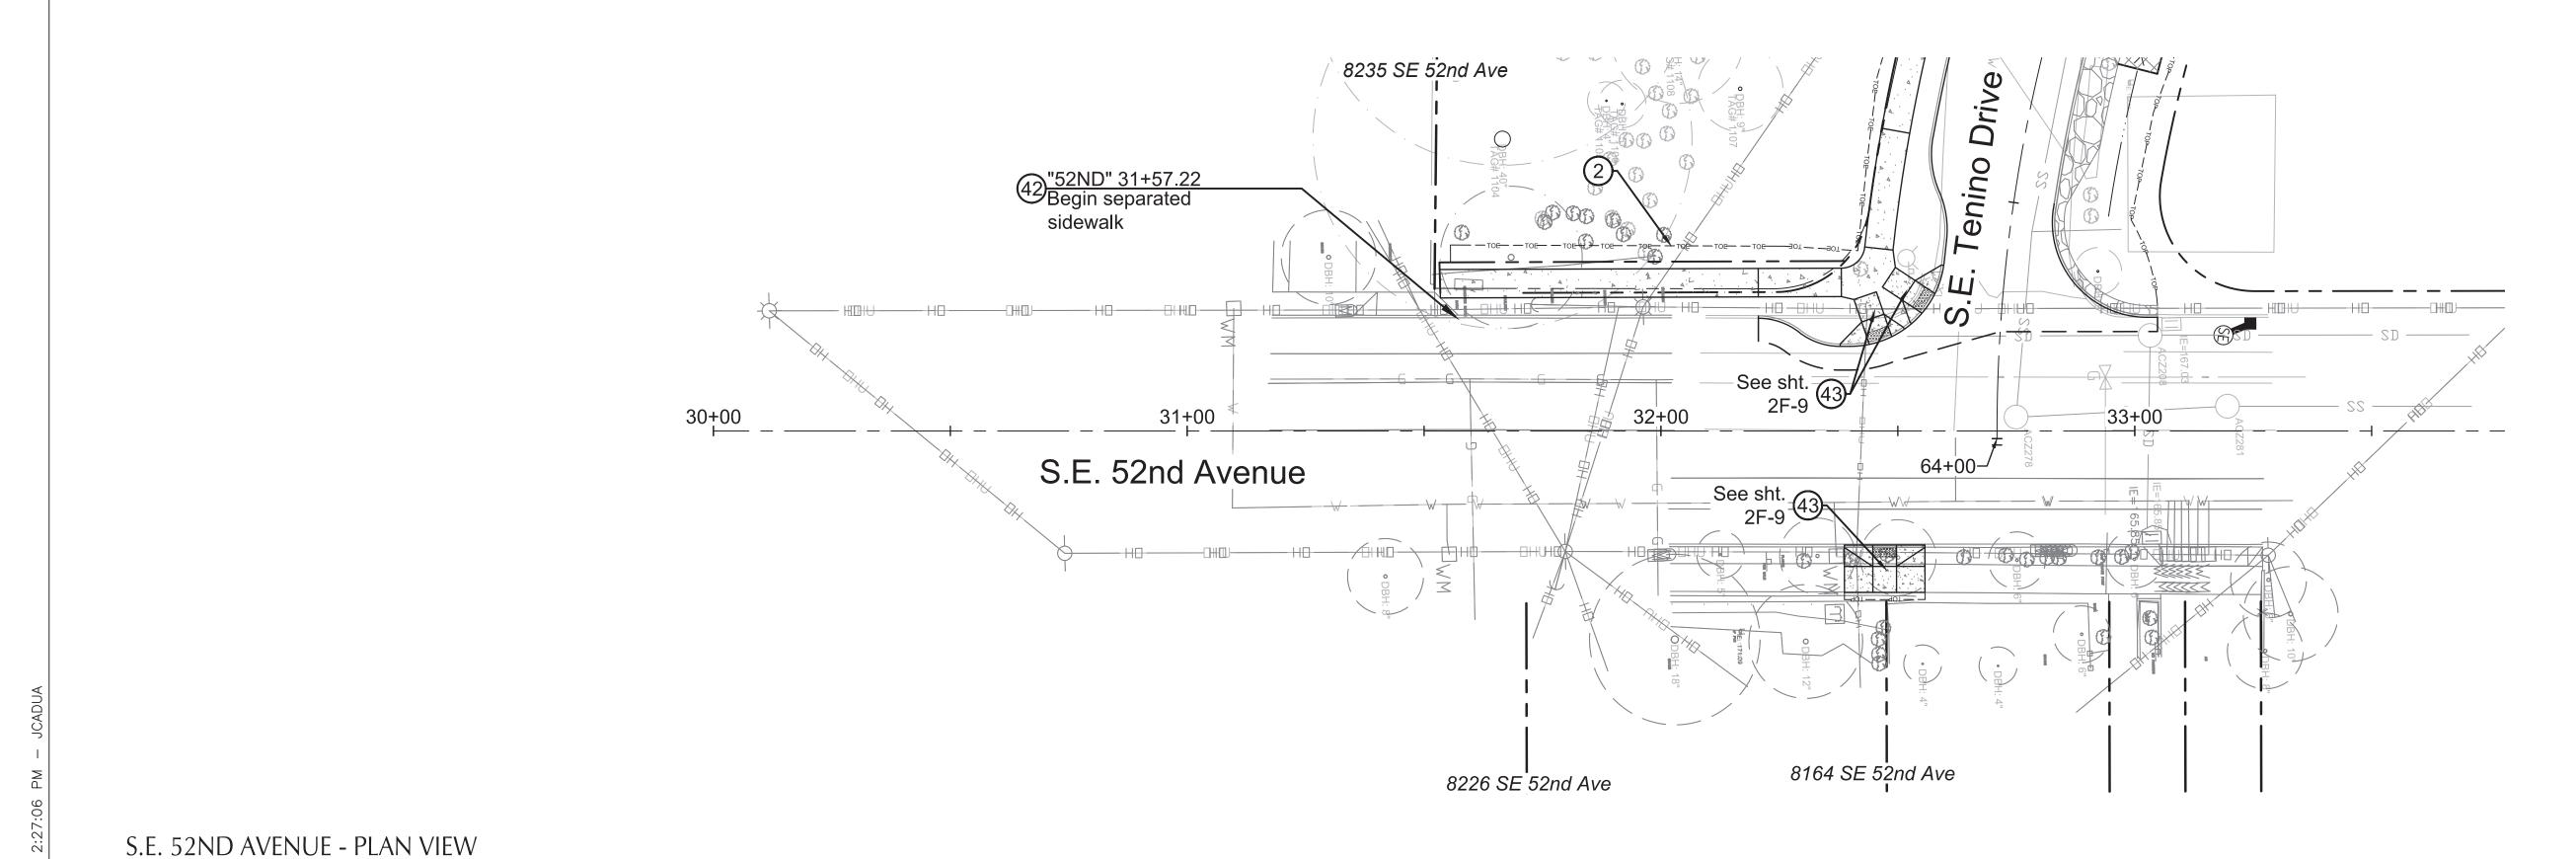

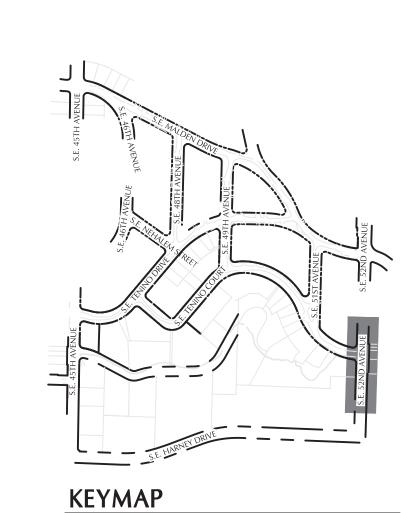

111 SW Fifth Ave., Suite 2500 Portland, OR 97204 O: 503.227.3251 F: 503.224.4681 www.kpff.com


NG 25 I	NOT   THE	Γ MEAS N DRAI	R DOES SURE !" WING IS SCALE.				
<u>.</u>						DESIGNED BY	DATE APPROVED
7						D. Murar / L. Burke	
ر ا						CAD BY	PROGRAM MGR.
- 20						R. Cadua	
Ω						CHECKED BY	CONSTR. MGR.
200						C. Vanderzanden	
¡	NO.	DATE		DESCRIPTION	APPD.		
=				REVICIONI			

SCALE: 1" = 20'

WARNING

£4.	APPRO\
PEINITE OF FOR	SUPERVISING
COASI	CITY ENGINE

et .	APPROVALS:		
OPTION	SUPERVISING ENGINEER	REG. PROF. ENGR. NO. 14956PE	
<b>/</b> *	CITY ENGINEER	REG. PROF. ENGR. NO. 51538PE	,

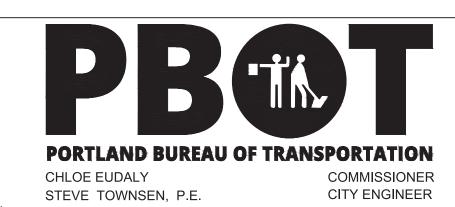

ORTLAND
REC
0
1851

Errol He	ights
Street and Storm	Improvemen

S.E. 52nd Avenue Street Plan and Profile

1s2e19 PROJECT NO. T00526.D42 SHEET NO.

25